GENERAL PERFORMANCE SPECIFICATIONS

CODES AND STANDARDS

ALL WORKMANSHIP IS TO BE OF A STANDARD EQUAL IN ALL RESPECTS TO GOOD BUILDING PRACTICE.

AT THE TIME OF PREPARATION, THIS PLAN WAS DRAWN IN ACCORDANCE WITH THE OWNER/BUILDER TO ENSURE THAT CHANGES MADE TO THE CODE ARE COMPLIED WITH AND ALL AMENDMENTS ARE INCORPORATED IN THE

PRIOR TO PROCEEDING WITH CONSTRUCTION, THE OWNER/BUILDER MUST VERIFY ALL INFORMATION, DIMENSIONS AND SPECIFICATIONS OF THIS PLAN. WRITTEN DIMENSIONS ALWAYS TAKE PRECEDENCE OVER SCALE MEASUREMENTS. ANY VARIANCE FROM STRUCTURAL DRAWINGS AND SPECIFICATIONS OR FROM CONDITIONS ENCOUNTERED AT THE JOB SITE, SHALL BE RESOLVED BY THE OWNER/BUILDER AND SUCH SOLUTIONS SHALL BE THEIR

SITE SPECIFICATIONS

SOLE RESPONSIBILITY.

BUILDING AND SITE GRADE ELEVATIONS SHALL BE CONFIRMED WITH UTILITY PROVIDERS AND LOCAL AUTHORITIES AND COMPLY WITH UTILITY SERVICE AND SITE DRAINAGE REQUIREMENTS.

ALL BUILDING AND UTILITY EXCAVATIONS SHALL BE FILLED AND COMPACTED IN 12" LAYERS TO MINIMUM 95% PROCTOR DENSITY TO ENSURE MINIMAL SETTLEMENT.

EXTERIOR WALLS AND TO THE CENTRE OF INTERIOR WALLS (WOOD STUD). CONTRACTOR IS TO VERIFY ALL DIMENSIONS PRIOR TO CONSTRUCTION.

<u>CONCRETE AND FOOTINGS</u> ALL CONCRETE TO HAVE A MINIMUM COMPRESSIVE STRENGTH OF 2,900 PSI (20 MPA) AT 28 DAYS.

CONCRETE FOOTINGS MUST BE PLACED ON UNDISTURBED OR COMPACTED SOIL TO AN ELEVATION BELOW FROST PENETRATION. FOOTINGS SHOWN ON THESE LESSER BEARING CAPACITY IS ENCOUNTERED, IT IS THE RESPONSIBILITY OF THE OWNER/BUILDER TO HAVE THE FOOTINGS REDESIGNED BY QUALIFIED PERSONS TO SUIT EXISTING CONDITIONS.

FLOOR ASSEMBLY LEGEND

(F1) <u>SLAB ON GRADE - GARAGE/DRIVEWAY</u>

- 4" THICK EXPOSED AGGREGATE 32 mPa CONCRETE REINFORCING @ 24" O.C. BOTH WAYS - COMPACTED GRANULAR FILL AND PREPARED SUBGE TO GEOTECH REPORT

(F2) SLAB ON GRADE - PATIO/SIDEWALK

- 4" THICK 32 mPa COLOURED CONCRETE SLAB W/ SM FINISH AND 10M REINFORCING @ 24" O.C. BOTH WAYS - COMPACTED GRANULAR FILL AND PREPARED SUBGF TO GEOTECH REPORT

(F3) <u>SLAB ON GRADE - LOWER FLOOR</u>

- FINISHED FLOORING

- 4" THICK, 32 mPa CONCRETE SLAB W/ 10M REINFORCING @ 24" O.C. BOTH WAYS - 10 MIL POLY VAPOUR BARRIER WITH SEALED SEAMS - R15 EPS EXPANDED RIGID INSULATION, MIN. COMPRESSIVE STRENGTH 25 LBS/PSI - COMPACTED GRANULAR FILL AND PREPARED SUBGRADE - REFER TO GEOTECH REPORT

EFFECTIVE RSI / R-VALUE OF ENTIRE ASSEMBLY MINIMUM RSI VALUE WITH HRV INSTALLED

(F4) MAIN FLOOR - OVER LIVING SPACE

- FINISHED FLOOR 11/32" PLYWOOD UNDERLAY (LINO OR TILE AREAS) - 3/4" T&G PLYWOOD SUBFLOOR, GLUED & SCREWED - 11 7/8" ENGINEERED I-JOIST 1/2" GYPSUM BOARD

*FILL END OF JOIST CAVITIES WITH R22 2LB CLOSED C

(F5) FLOOR OVER GARAGE

FINISHED FLOOR 11/32" PLYWOOD UNDERLAY (LINO OR TILE AREAS) - 3/4" T&G PLYWOOD SUBFLOOR, GLUED & SCREWED

11 7/8" ENGINEERED I-JOIST FILL I-JOIST WITH DENSE PACK CELLULOSE INSULATION @ 3-1/2 POUNDS PER CUBIC FOOT. (APPROVED ALTERNATE MINERAL WOOL BATTS) **ÎNSULWEB CELLULOSE NETTING**

1/2" GYPSUM BOARD *FILL END OF JOIST CAVITIES, KITCHEN SINK

PLUMBING DRAIN AND SUPPLY LINES WITH R22 2LB CLOSED CELL SPRAY INSULATION.

EFFECTIVE RSI / R-VALUE OF ENTIRE ASSEMBLY MINIMUM RSI VALUE WITH HRV INSTALLED

(F6) BALCONY

- VINYL DECK MEMBRANE - WOOD DECKING - 2x10" DECK JOISTS @ 16" O.C. - VENTED ALUMINIUM SOFFIT



CONSTRUCTION OF THIS PLAN. ALL WORK SHALL CONFORM TO LOCAL BUILDING

CODES AND BYLAWS WHICH MAY TAKE PRECEDENCE.

DIMENSIONS ARE SHOWN TO EXTERIOR OF ROUGH FRAMING (WOOD STUD) ON

ALL FOUNDATION WALLS 24" (600 MM) AND HIGHER SHOULD HAVE ONE HORIZONTAL PLATES ARE TO BE ANCHORED TO CONCRETE WITH 1/2" 10 MM REINFORCING BAR 3" (75 MM) FROM THE TOP. CORNER REINFORCING TO BE LAPPED MINIMUM 24" (600 MM). ALL FOOTINGS ARE TO HAVE TWO 1/2" (#4) REINFORCING BARS. THE REINFORCING BARS ARE TO BE SITUATED SUCH THAT ONE BAR IS 3" (75 MM) CLEAR OF THE SIDE THE CURRENT EDITION OF THE B.C. BUILDING CODE. IT IS THE RESPONSIBILITY OF AND BOTTOM OF THE FOOTING ON BOTH SIDES OF THE FOOTING. GRADES SHOWN ON ELEVATIONS ARE ESTIMATED. ADJUST ON SITE AS REQUIRED. RETAINING WALLS OTHER THAN THE FOUNDATION WALLS OF THE RESIDENCE ARE BEYOND THE SCOPE OF THESE DRAWINGS UNLESS OTHERWISE NOTED. ABOVE GRADE MASONRY ALL ABOVE GRADE MASONRY IS TO CONFORM TO THE BC BUILDING CODE. IF BRICK VENEER IS TO BE INSTALLED, COUNTER FLASHING SHALL BE INSTALLED UP TO 8" (200 MM) BEHIND THE WEATHER RESISTANT BARRIER AND BELOW THE BOTTOM COURSE WITH VERTICAL JOINTS RAKED CLEAN. WEEP HOLES 24" (600 MM) O.C.. <u>CARPENTRY</u> ALL DIMENSIONS AND GRIDLINES AT EXTERIOR WALLS ARE TO FACE OF SHEATHING INTERIOR DIMENSIONS ARE TO MIDDLE OF STUD AT PARTITIONS AND EDGE OF STUD REFER TO FLOOR/WALL/ROOF SCHEDULE FOR INSULATION AT STAIR OPENINGS UNLESS OTHERWISE NOTED TYPF FRAMING LUMBER SHALL BE NUMBER TWO (2) OR BETTER SPRUCE UNLESS OTHERWISE SPECIFIED ON THE PLAN. ALL BEAM AND LINTEL SIZES SHOWN ON THE DRAWINGS TO BE REVIEWED & CONFIRMED BY TRUSS MANUFACTURER AND CONTRACTOR. ANY BEAM OR LINTEL SIZES PROVIDED BY TRUSS/FLOOR MANUFACTURER TAKE PRECEDENCE. JOISTS ARE TO BE DOUBLED UNDER PARALLEL PARTITIONS.

JOISTS SHALL BE PLACED TO ACCOMMODATE PLUMBING, IN THE EVENT OF A DISCREPANCY PLEASE CONTACT FLOOR SUPPLIER BEFORE ANY ALTERATIONS OR CUTS ARE MADE.

WOOD IN CONTACT WITH CONCRETE SHALL BE DAMPPROOFED WITH A SILL PLATE GASKET AND PRESSURE TREATED WITH A WATERBORNE PRESERVATIVE DRAWINGS HAVE BEEN DESIGNED FOR SOIL BEARING CAPACITY OF 2,500 PSF. IF A OR OTHER APPROVED METHOD ON EXTERIOR WALLS.

INTERIOR FRAMING TO BE 4" (100 MM) CLEAR OF BACK AND SIDES OF FIREBOX AND 2" (50 MM) CLEAR OF BRICK CHIMNEYS. FRAME EXTERIOR WALLS 1" (25 MM) CLEAR FROM EXTERIOR FIREPLACES.

ANCHOR BOLTS, MAXIMUM 6 FT. O.C. OR OTHER APPROVED METHOD.

FLUSH FRAMED WOOD MEMBERS SHALL BE ANCHORED WITH 200 LB. JOIST HANGERS UNLESS OTHERWISE SPECIFIED. STAMPED AND SEALED SHOP DRAWINGS SHALL BE PROVIDED FOR ALL STRUCTURAL BEAM, FLOOR AND ROOF SYSTEMS.

LINTELS ARE (2) 2x10" SPF. w/ 2" THICK RIGID INSULATION SEALED AT PERIMETER U.N.O.

PROVIDE 2x6" SOLID BLOCKING AT TOWEL BARS, TOILET PAPER HOLDERS, COAT HOOKS, MIRRORS AND WALL MOUNTED VANITIES.

INSULATION/VENTILATION

MINIMUM INSULATION REQUIREMENTS: ROOF/CEILING - R 60

WALLS - 2 X 6 - R 22 GARAGE CEILING - R 32

WALLS AND CEILINGS BETWEEN RESIDENCE AND ATTACHED GARAGE SHALL BE INSULATED.

INSULATION REQUIREMENTS MAY VARY WITH HEATING SYSTEMS AND WITH LOCAL CONDITIONS.

ALL ROOF SPACES SHALL BE VENTILATED WITH SOFFIT, ROOF HEIGHT OF STANDARD OUTLETS (CENTER OF BOX) OR GABLE VENTS OR A COMBINATION OF THESE, EQUALLY DISTRIBUTED BETWEEN THE TOP OF THE ROOF SPACE AND SOFFITS.

MISCELLANEOUS

CAULK OVER AND AROUND ALL EXTERIOR OPENINGS USING NON-HARDENING CAULKING COMPOUND.

FLASH ALL CHANGES OF MATERIALS ON EXTERIOR WALLS. FLASH OVER ALL EXTERIOR OPENINGS.

ALL SIDING OR STUCCO TO BE A MINIMUM OF 8" (150 MM) ABOVE FINISHED GRADE. ALL BALCONY RAILINGS TO BE 3'6" (1070 MM) IN HEIGHT. MAXIMUM

SPACING BETWEEN VERTICAL MEMBERS IS 4" (100 MM). MINIMUM DISTANCE BETWEEN HORIZONTAL RAILS TO BE 32" (800 MM). TOP RAIL TO SUSTAIN OUTWARD LOAD OF 40 LBS. PER LINEAL FOOT. COAT AND CLOTHES CLOSETS SHALL HAVE AT LEAST ONE ROD AND SHELF WITH MINIMUM DEPTH OF 24" UNLESS OTHERWISE STATED. LINEN CLOSET SHALL HAVE 5 ADJUSTABLE SHELVES WHEREVER POSSIBLE. BROOM CLOSETS SHALL HAVE ONE SHELF. WHERE TUBS OR SHOWERS OCCUR, PROVIDE MOISTURE RESISTANT GYPSUM BOARD. ASPHALT (TAR) PAPER NOT ALLOWED. USE ONLY TYVEK OR APPROVED WEATHER RESISTANT BARRIER EQUIVALENT. TAPE ALL VERTICAL AND HORIZONTAL SEAMS AS PER MANUFACTURERS INSTRUCTIONS. ELECTRICAL SPECIFICATIONS 200 AMP SERVICE CONNECTION ALL ELECTRICAL JUNCTION BOXES TO BE NUTEK PLASTIC BOX WITH AIRTIGHT FOAM GASKET COUPLED WITH PLASTIC VAPOUR BARRIER BOOT, PROVIDE SPRAY FOAM AT WIRE PENETRATION ALL ELECTRICAL OUTLET AND FIXTURES LOCATIONS ARE TO BE CONFIRMED WITH OWNER. ALL ELECTRICAL OUTLETS, SERVICES AND FIXTURES TO COMPLY WITH CURRENT ELECTRICAL CODES. ALL ELECTRICAL SERVICES TO BE

- SWITCHES 46"

HVAC SPECIFICATIONS

PER TRADE STANDARDS.

_AB W/ 10M \DE - REFER		
OTH TROWEL		
EFFECTIVE RSI (INT. AIR FILM) 0.16 0.12 0.04 0.00 2.64 - 2.96 1.96	R-VALUE 0.90 0.68 0.22 0.00 15.00 - 16.80 11.12	
LL SPRAY INSU	ILATION	
EFFECTIVE RSI (INT. AIR FILM) 0.16 0.00 0.00 5.55 0.00 0.08	<u>R-VALUE</u> 0.91 0.00 0.00 31.5 0.00 0.45	
5.79 4.51	32.88 25.61	
	ADE - REFER OTH TROWEL ADE - REFER EFFECTIVE RSI (INT. AIR FILM) 0.16 0.04 0.00 2.64 - 2.96 1.96 1.96 1.96	ADE - REFER OTH TROWEL DE - REFER EFFECTIVE R-VALUE RSI (INT. AIR FILM) 0.16 0.12 0.04 0.04 0.02 0.00 2.64 15.00 2.96 1.96 1.96 1.12 EFFECTIVE R-VALUE RSI (INT. AIR FILM) 0.16 0.00 0.

WALL ASSEMBLY LEGEND			
FOUNDATION WALL	EFFECTIVE RSI	<u>R-VALUE</u>	
- R15 EPS EXPANDED RIGID INSULATION - 8" CONCRETE FOUNDATION WALL - 2 LAYERS OF BITUMINUOUS DAMPPROOFING	2.13 0.08 0.00	12.09 0.45 0.00	
EFFECTIVE RSI / R-VALUE OF ENTIRE ASSEMBLY MINIMUM RSI VALUE WITH HRV INSTALLED	2.21	12.54	
W2 FOUNDATION WALL - LOWER FLOOR	EFFECTIVE RSI	<u>R-VALUE</u>	
- 1/2" GYPSUM BOARD - 2x4" WOOD STUDS @ 24" O.C. WITH R12 FIBREGLASS BATT INSULATION BETWEEN STUDS - R15 EPS RIGID INSULATION w/ TAPED SEAMS - 8" CONCRETE FOUNDATION WALL - 2 LAYERS OF BITUMINUOUS DAMP PROOFING	(INT. AIR FILM) 0.12 0.08 1.19 2.11 2.64 0.08 0.00	0.68 0.45 11.98 14.99 0.46 0.00	
EFFECTIVE RSI / R-VALUE OF ENTIRE ASSEMBLY MINIMUM RSI VALUE WITH HRV INSTALLED	5.59 2.98	26.96 16.92	7
W3 EXTERIOR WALL	EFFECTIVE RSI	<u>R-VALUE</u>	Contract of the second s
- 1/2" GYPSUM BOARD - 6 MIL POLY VAPOUR BARRIER - R22 FIBREGLASS BATT INSULATION	(INT. AIR FILM) 0.12 0.08 0.00	0.68 0.45 0.00	
- 2x6" WOOD STUDS @ 24" O.C. - 7/16" PLYWOOD SHEATHING - 2 LAYERS OF TYVEK STUCCOWRAP - CLADDING, STUCCO(REFER TO ELEVATIONS	2.67 0.096 0.00	15.16 0.54 0.00	
FOR CLADDING TYPE)	0.0009 - 0.023 (EXT. AIR FILM) 0.03	0.02 - 0.13 0.17	
EFFECTIVE RSI / R-VALUE OF ENTIRE ASSEMBLY MINIMUM RSI VALUE WITH HRV INSTALLED	2.99 - 3.019 2.97	17.13 16.86	
W4 WALL BETWEEN HOUSE & GARAGE	EFFECTIVE RSI	<u>R-VALUE</u>	GARAGE
- 1/2" GYPSUM BOARD - 6 MIL POLY VAPOUR BARRIER - R22 FIBREGLASS BATT INSULATION	(INT. AIR FILM) 0.12 0.08 0.00	0.68 0.45 0.00	
- 2x6" WOOD STUDS @ 24" O.C. - 1/2" GYPSUM BOARD	2.67 0.08 (EXT. AIR FILM) 0.03	15.16 0.45 0.17	
EFFECTIVE RSI / R-VALUE OF ENTIRE ASSEMBLY MINIMUM RSI VALUE WITH HRV INSTALLED	2.98 2.81	16.91 15.96	HOUSE
 INTERIOR WALL 1/2" GYPSUM BOARD 2x4" WOOD STUDS @ 16" O.C. 1/2" GYPSUM BOARD *2x6" WOOD STUDS AT PLUMBING WALLS WHERE INDICATED 			
W6 DUCT WALL & BULKHEADS - 2xX" WOOD STUDS @ 16" O.C. OR LIGHTWEIGHT STEEL FRAMING - 1/2" GYPSUM BOARD *ENSURE VAPOUR BARRIER CONTINOUS BEYOND, AT ALL EXTERIOR WALLS			

R1 ROOF	EFFECTIVE RSI	<u>R-VALUE</u>
- 2-PLY SBS TORCH-DOWN ROOF MEMBRANE - 5/8" PLYWOOD DECKING WITH "H" CLIPS - ENGINEERED ROOF TRUSS WITH VENTED ALUMINIUM SOFFIT AT EAVES TYP. U.N.O.	(EXT. AIR FILM) 0.03 0.00 0.14	0.17 0.00 0.77
- MIN AIR SPACE 2-1/2"	0.16	0.91
 R60 BLOWN-IN FIBREGLASS INSULATION OR LOOSE FILL CELLULOSE 6MIL POLY VAPOUR BARRIER w/ SEALED SEAMS 1/2" GYPSUM BOARD 	10.63 0.00 0.08 (INT. AIR FILM) 0.11	60.00 0.00 0.45 0.62
EFFECTIVE RSI / R-VALUE OF ENTIRE ASSEMBLY MINIMUM RSI VALUE WITH HRV INSTALLED	7.35 6.97	41.72 39.58
(R2) BALCONY FLOOR/ROOF OVER GARAGE	EFFECTIVE	<u>R-VALUE</u>
	<u>RSI</u> (EXT. AIR FILM) 0.03	0.17
- VINYL DECK MEMBRANE - 5/8" T&G PLYWOOD DECKING - 2xX" TAPED WOOD BLOCKING - 2" X 6" WOOD FLOOR JOISTS @ 16" O.C.	0.135 0.00 0.00	0.77 0.00 0.00
 R28 2LB SPRAY FOAM INSULATION TO UNDERSIDE OF DECKING DENSEPACK CELLULOSE INSULATION @ 3-1/2 LBS/FT3 (APPROVED ALTERNATE MINERAL WOOL BATTS) 	4.93	28.00
- INSULWEB CELLULOSE NETTING - 1/2" GYPSUM WALLBOARD	0.00 0.08 (INT. AIR FILM) 0.11	0.00 0.45 0.62
	5.285	30.01 25.61

1x4" T+G VENTED CEDAR SOFFIT STAIR ASSEMBLY LEGEND (S1) EXTERIOR STAIRS - STEEL C-CHANNEL WITH TRAYS - HOLES TO BE DRILLED THROUGH BOTTOM OF TRAYS FOR MOISTURE DRAINAGE - PAVERS SET INTO TRAYS WITH GROUT

(S2) INTERIOR STAIRS FINISHED FLOORING

- 1" PLYWOOD TREADS AND 3/4" RISERS GLUED AND SCREWED - 2x12" #1 FIR STRINGERS WITH SINGLE 2x12" STRINGER AT MID-TRFAD - 1/2" GYPSUM BOARD ON UNDERSIDE OF STAIRS

INSTALLED BY A QUALIFIED TRADESMAN.

- WALL OUTLETS 14" - OUTLETS ABOVE COUNTERTOP 6"


ALL HVAC SYSTEMS TO COMPLY WITH BC BUILDING CODE.

ALL HVAC SYSTEMS TO BE DESIGNED BY A QUALIFIED DESIGNER.


ALL FIXTURES AND MATERIALS TO BE CSA APPROVED.

ALL EQUIPMENT AND APPLIANCES TO BE INSTALLED AND TESTED AS

ROOF ASSEMBLY LEGEND

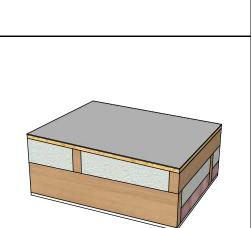

- 2x10" @ 16" O.C. ROOF JOISTS 1x3" WOOD STRAPPING @ 16" O.C.

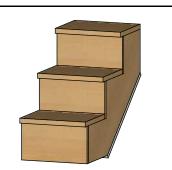

DOOR REFERENCE NUMBER (001A) REFER TO DOOR SCHEDULE FOR SPECIFIC INFORMATION

SYMBOLS LEGEND

ROOM NUMBER

DETAIL NUMBER

SHEET NUMBER

A BUILDING SECTION NUMBER

WALL SECTION NUMBER

INTERIOR ELEVATION NUMBER

SHEET NUMBER

SHEET NUMBER

SHEET NUMBER

KEYNOTE NUMBER

REVISION NUMBER

WALL TYPE

FLOOR TYPE

ROOF TYPE

CONTROL POINT

SPOT ELEVATION

LOAD BEARING PARTITION

POINT LOAD

WINDOW REFERENCE LETTER

ROOM ROOM NAME

111

 $\langle A \rangle$

\A11.

A4.1

A4.1

\A4.1

(#)

\w1/

(F1)

(R1)

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SITE NORTH PROJECT NORTH

DATE	ISSUED FOR
2016-02-04	PRICING
2016-03-23	PRICING
2016-07-29	PERMIT / CONSTRUCTION
2016-10-04	ENGINEERING
2016-11-25	CONSTRUCTION
2018-05-14	CONSTRUCTION R1
PROJECT TITI	LE #1502

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2880 Outlook Way, Lot 20 Naramata, BC

SHEET TITLE


Information Sheet SCALE

DRAWING NUMBER





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SHEET TITLE

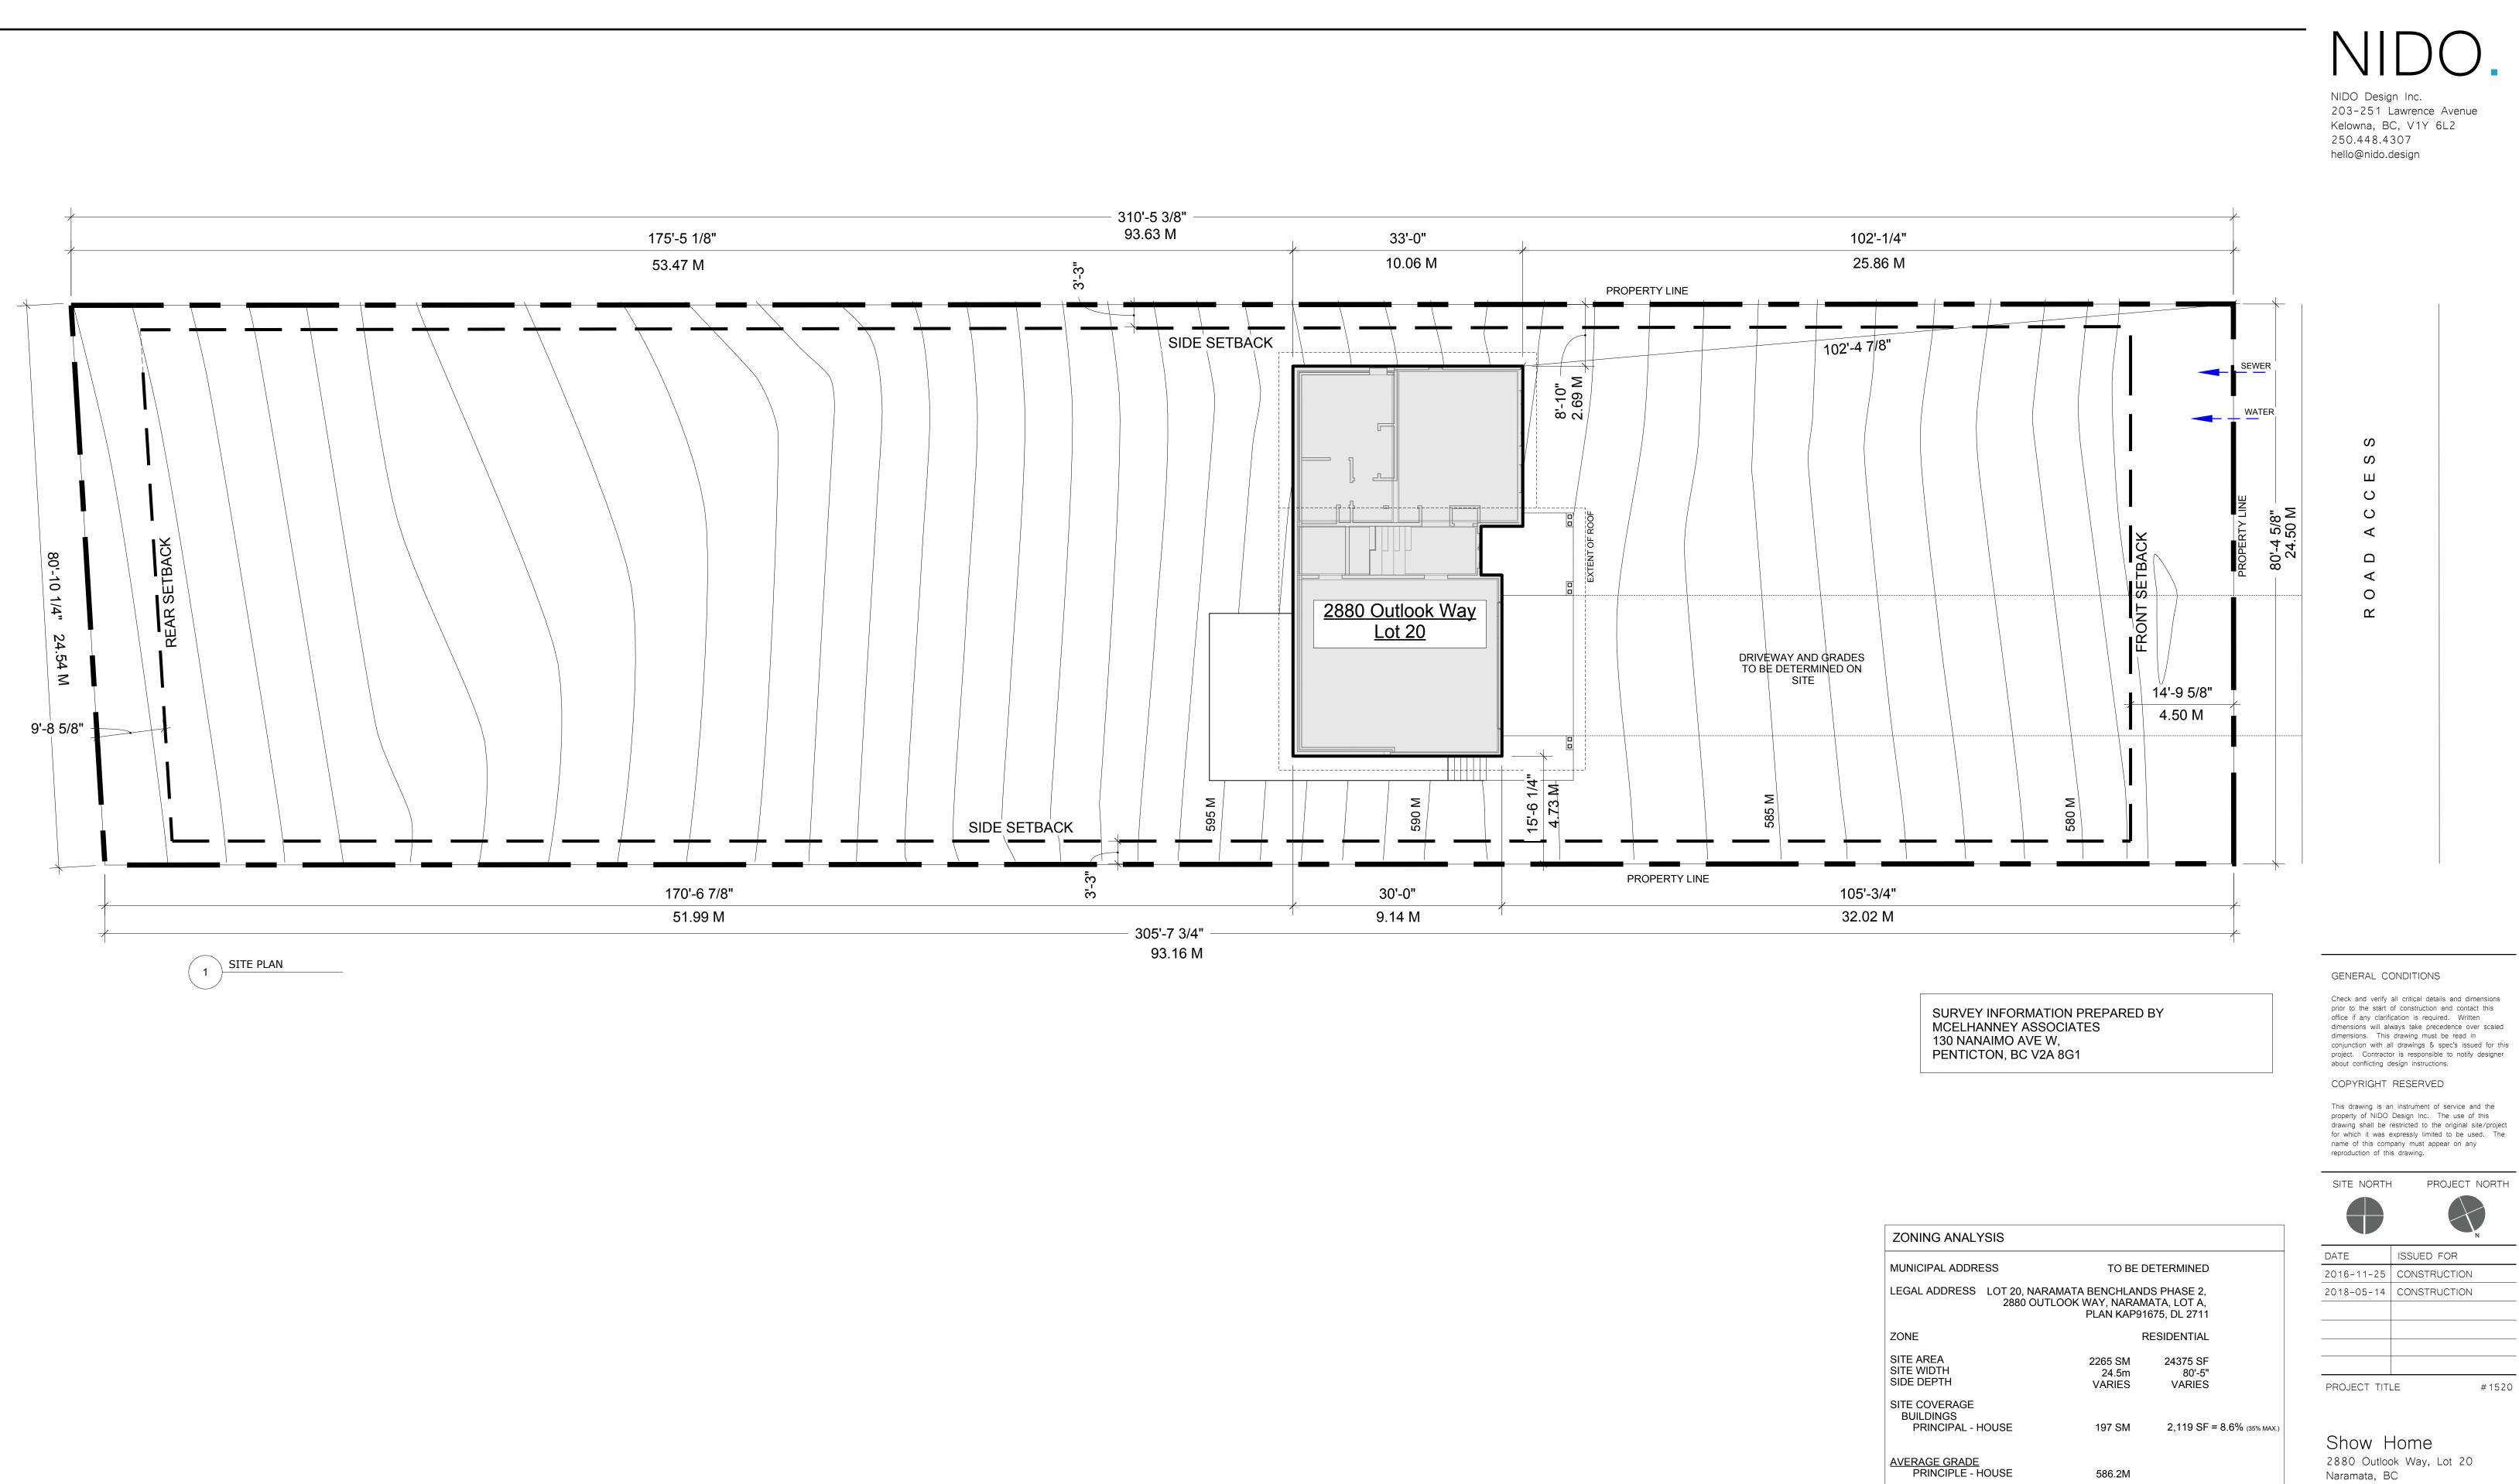Site Plan SCALE

DRAWING NUMBER


3/32" = 1'-0"


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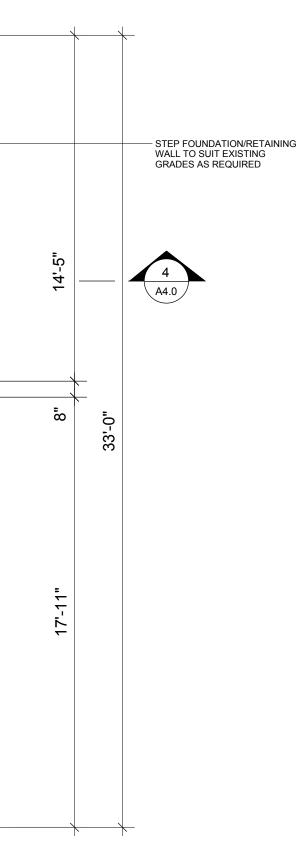
ZONING ANALYSIS		
MUNICIPAL ADDRESS	TO BE DE	ETERMINED
LEGAL ADDRESS LOT 20, NARAMA 2880 OUTLOC	TA BENCHLAND K WAY, NARAMA PLAN KAP916	ATA, LOT A,
ZONE	RI	ESIDENTIAL
SITE AREA SITE WIDTH SIDE DEPTH	2265 SM 24.5m VARIES	24375 SF 80'-5" VARIES
SITE COVERAGE BUILDINGS PRINCIPAL - HOUSE	197 SM	2,119 SF = 8.6% (35% MAX.)
AVERAGE GRADE PRINCIPLE - HOUSE	586.2M	
BUILDING HEIGHT PRINCIPLE - HOUSE (2 STOREYS)	7.3 M (12.0M	1 MAX) 23'-11" (39.4' MAX)
FLOOR AREA SUMMARY		GROSS SF
MAIN FLOOR LOWER FLOOR		1,666 SF 962 SF
TOTAL		2,628 SF

766 SF 453 SF

GARAGE COVERED BALCONY



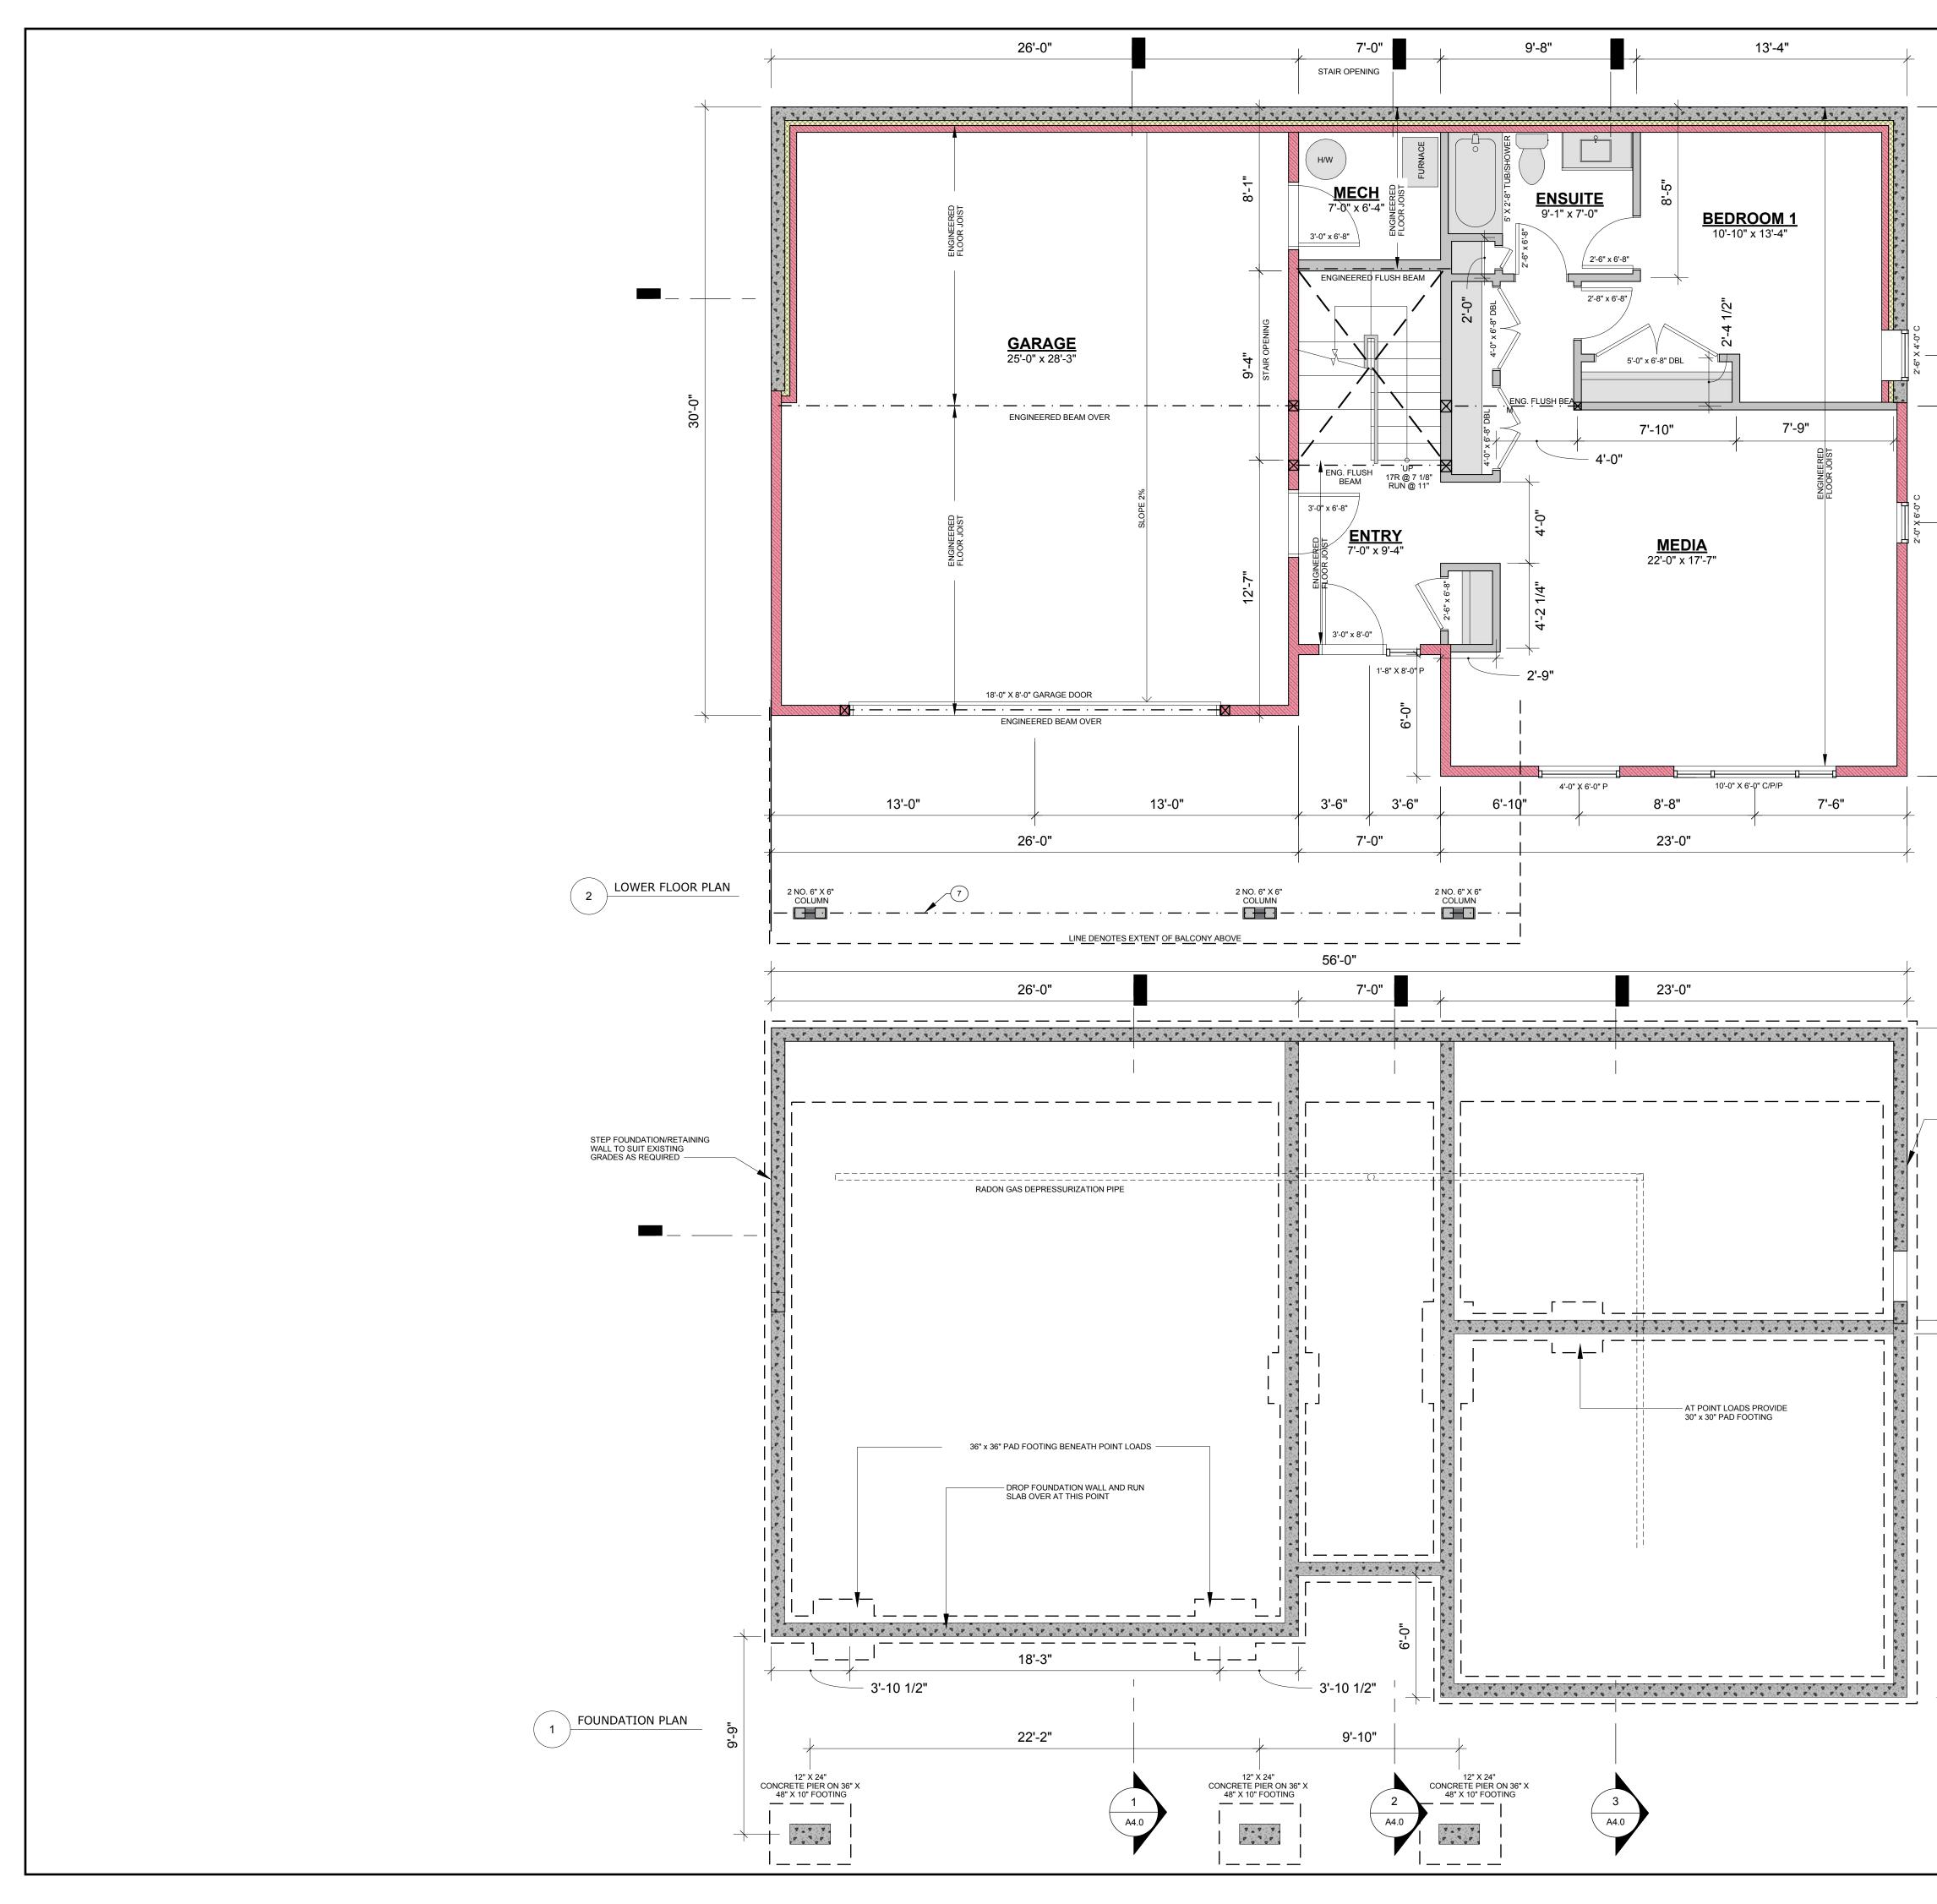

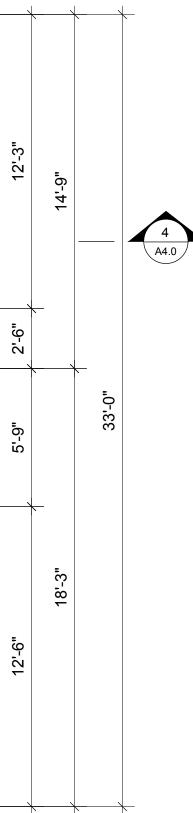

NIDO


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 2016-03-23
 PRICING

 2016-07-29
 PERMIT / CONSTRUCTION

 2016-10-04
 ENGINEERING

 2016-11-25
 CONSTRUCTION

 2018-05-14
 CONSTRUCTION R1

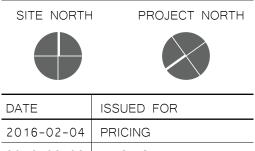 PROJECT TITLE
 #1502

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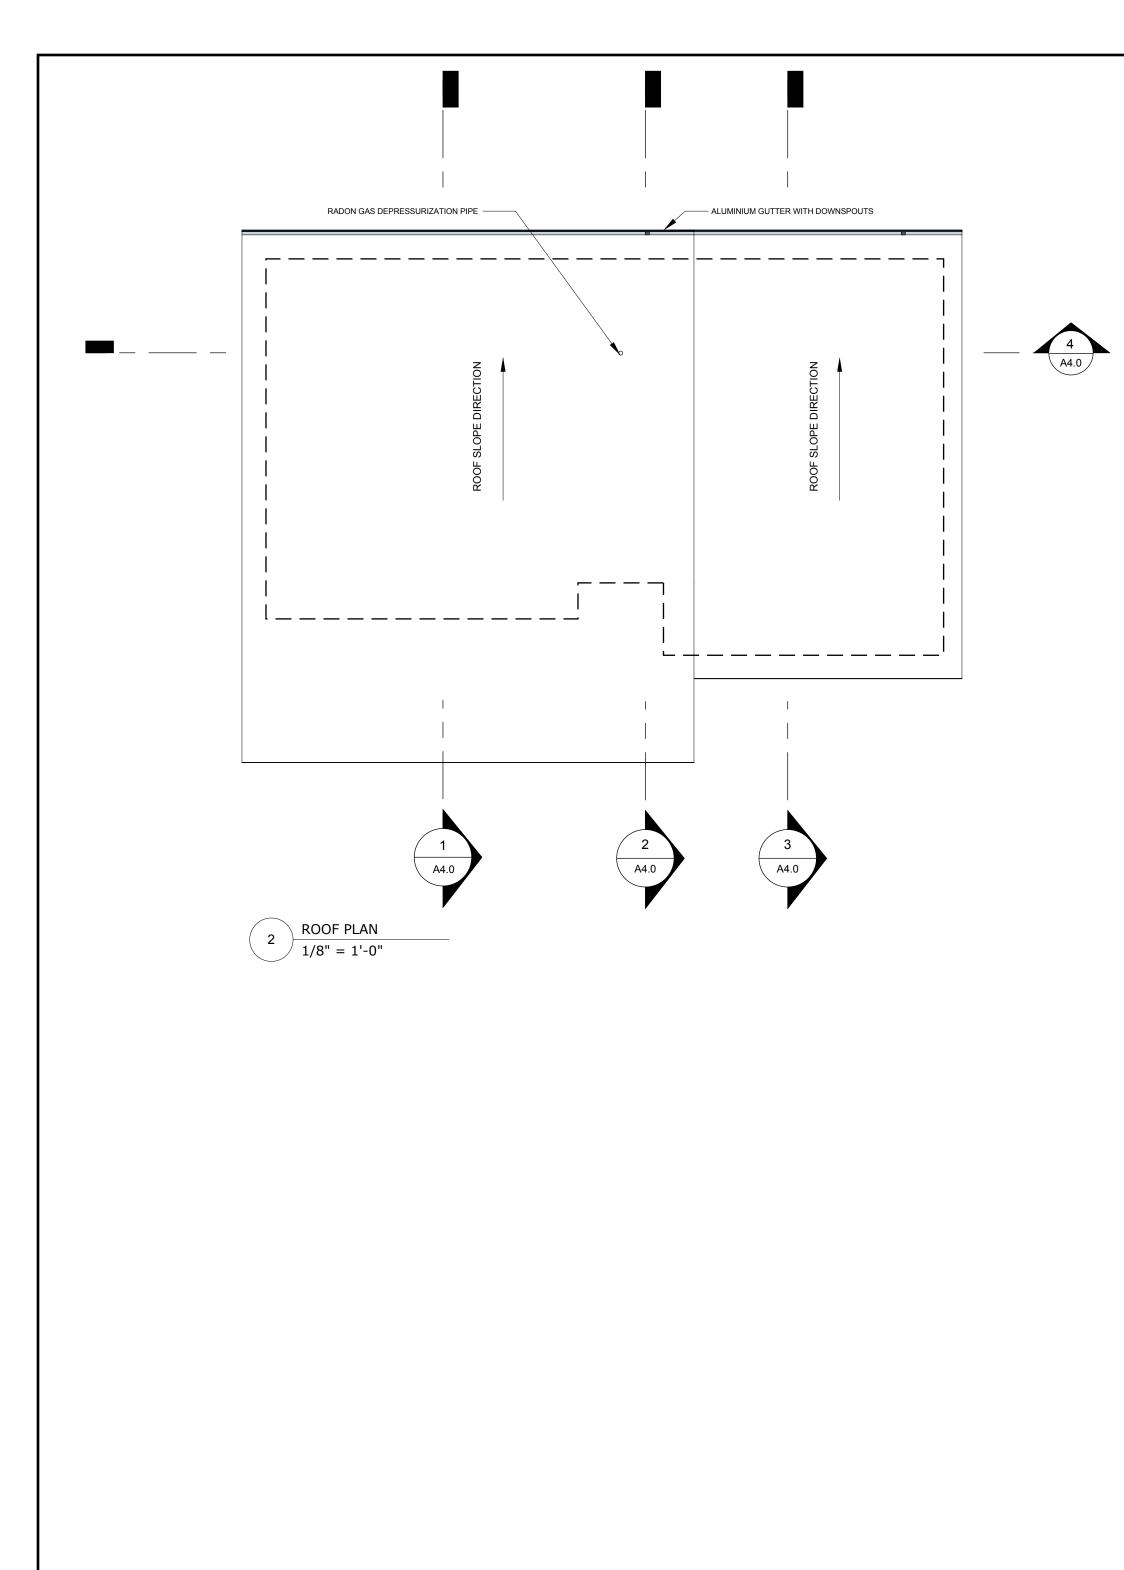
2880 Outlook Way, Lot 20 Naramata, BC


SHEET TITLE

Foundation & Lower Floor Plans

DRAWING NUMBER

A2.0



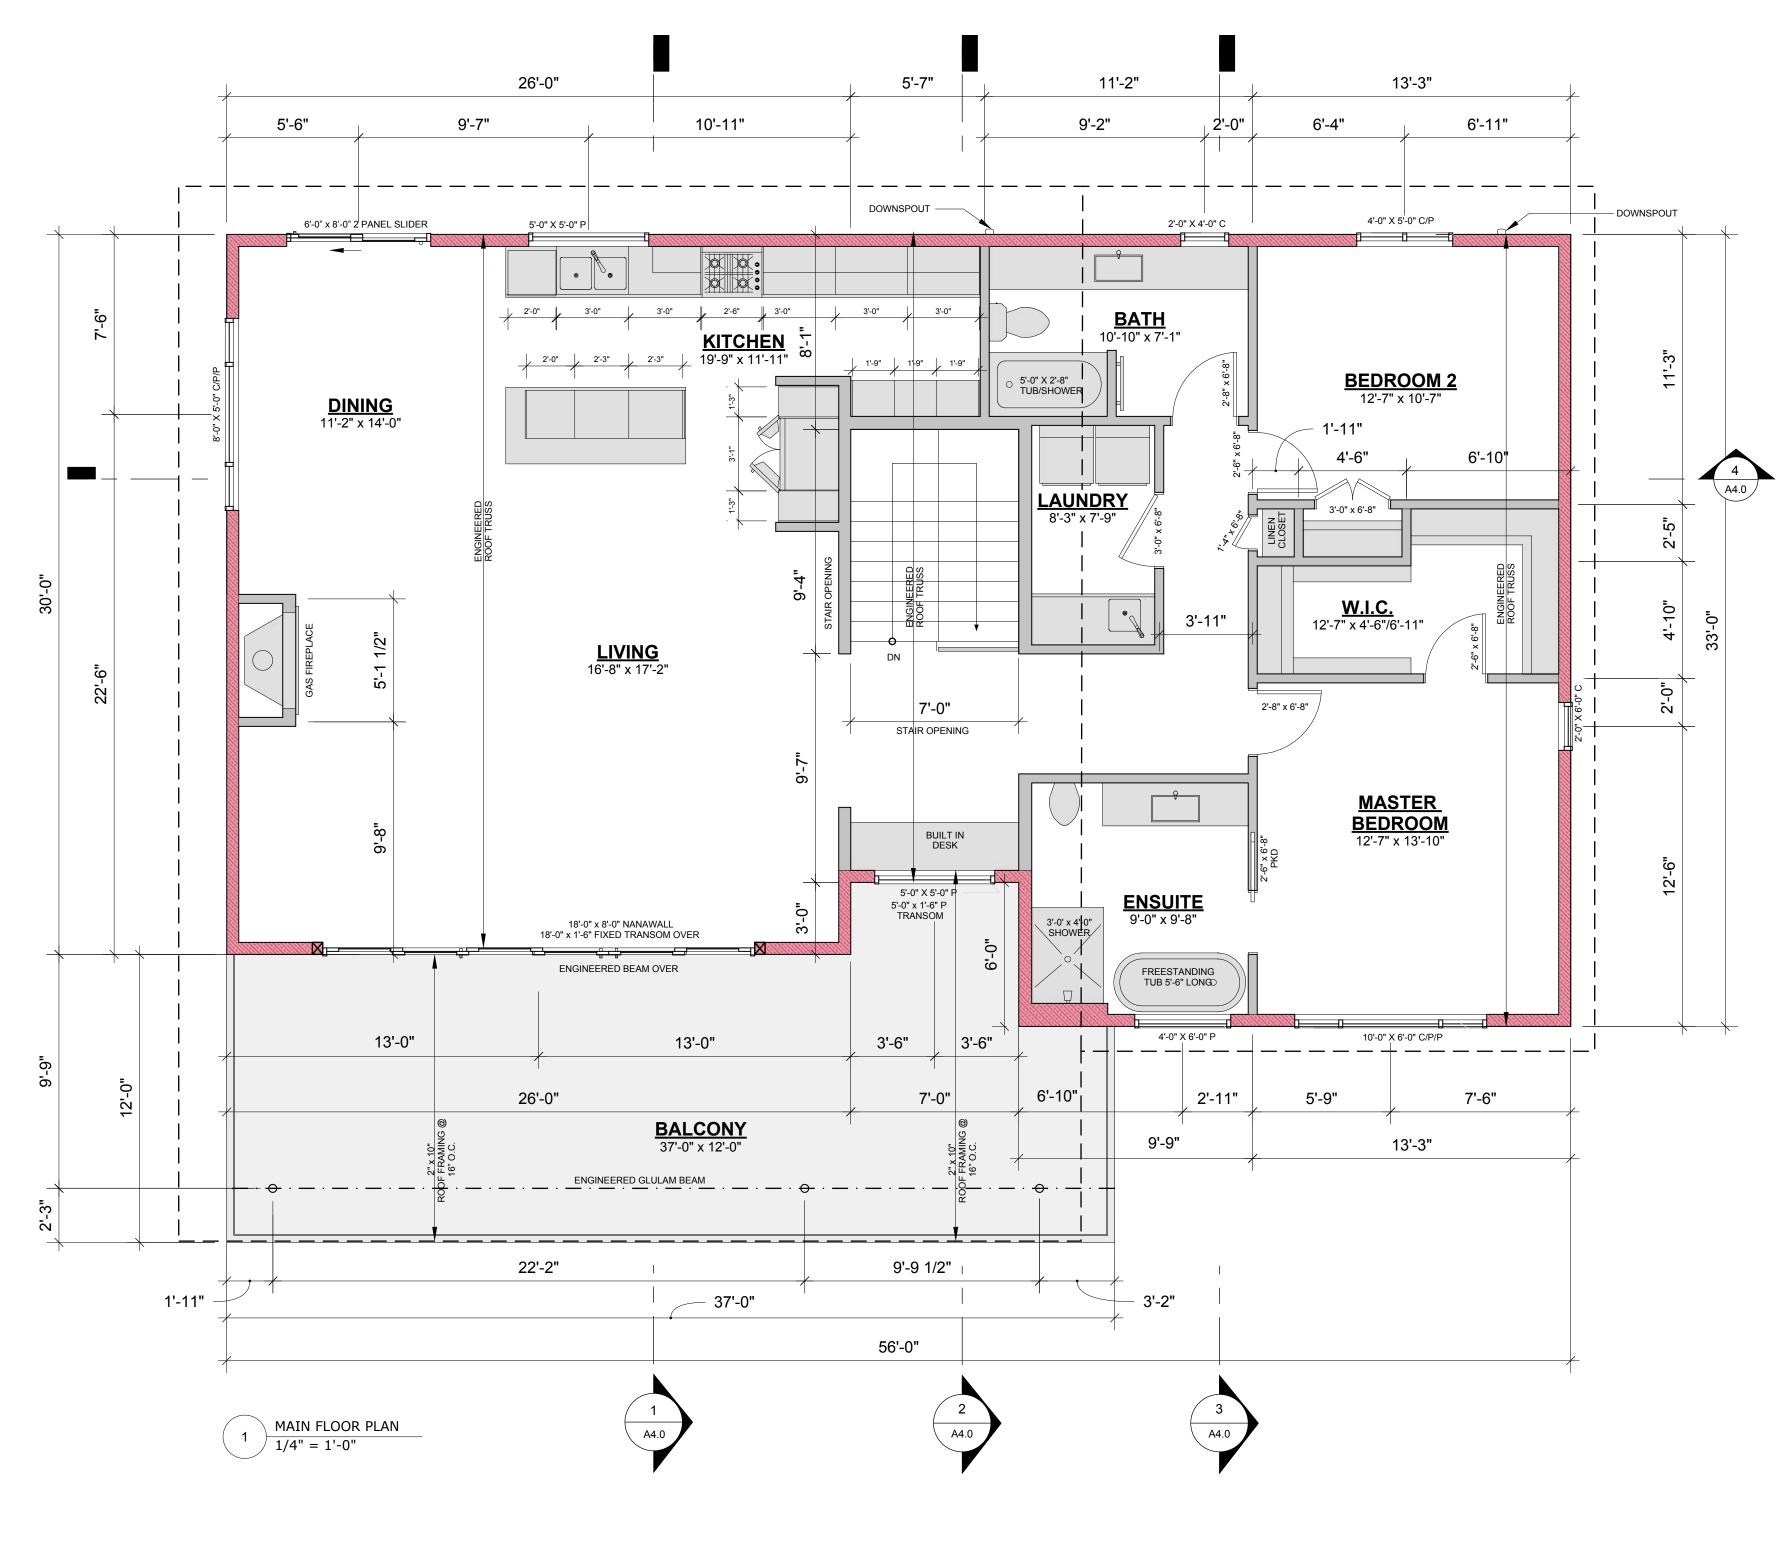




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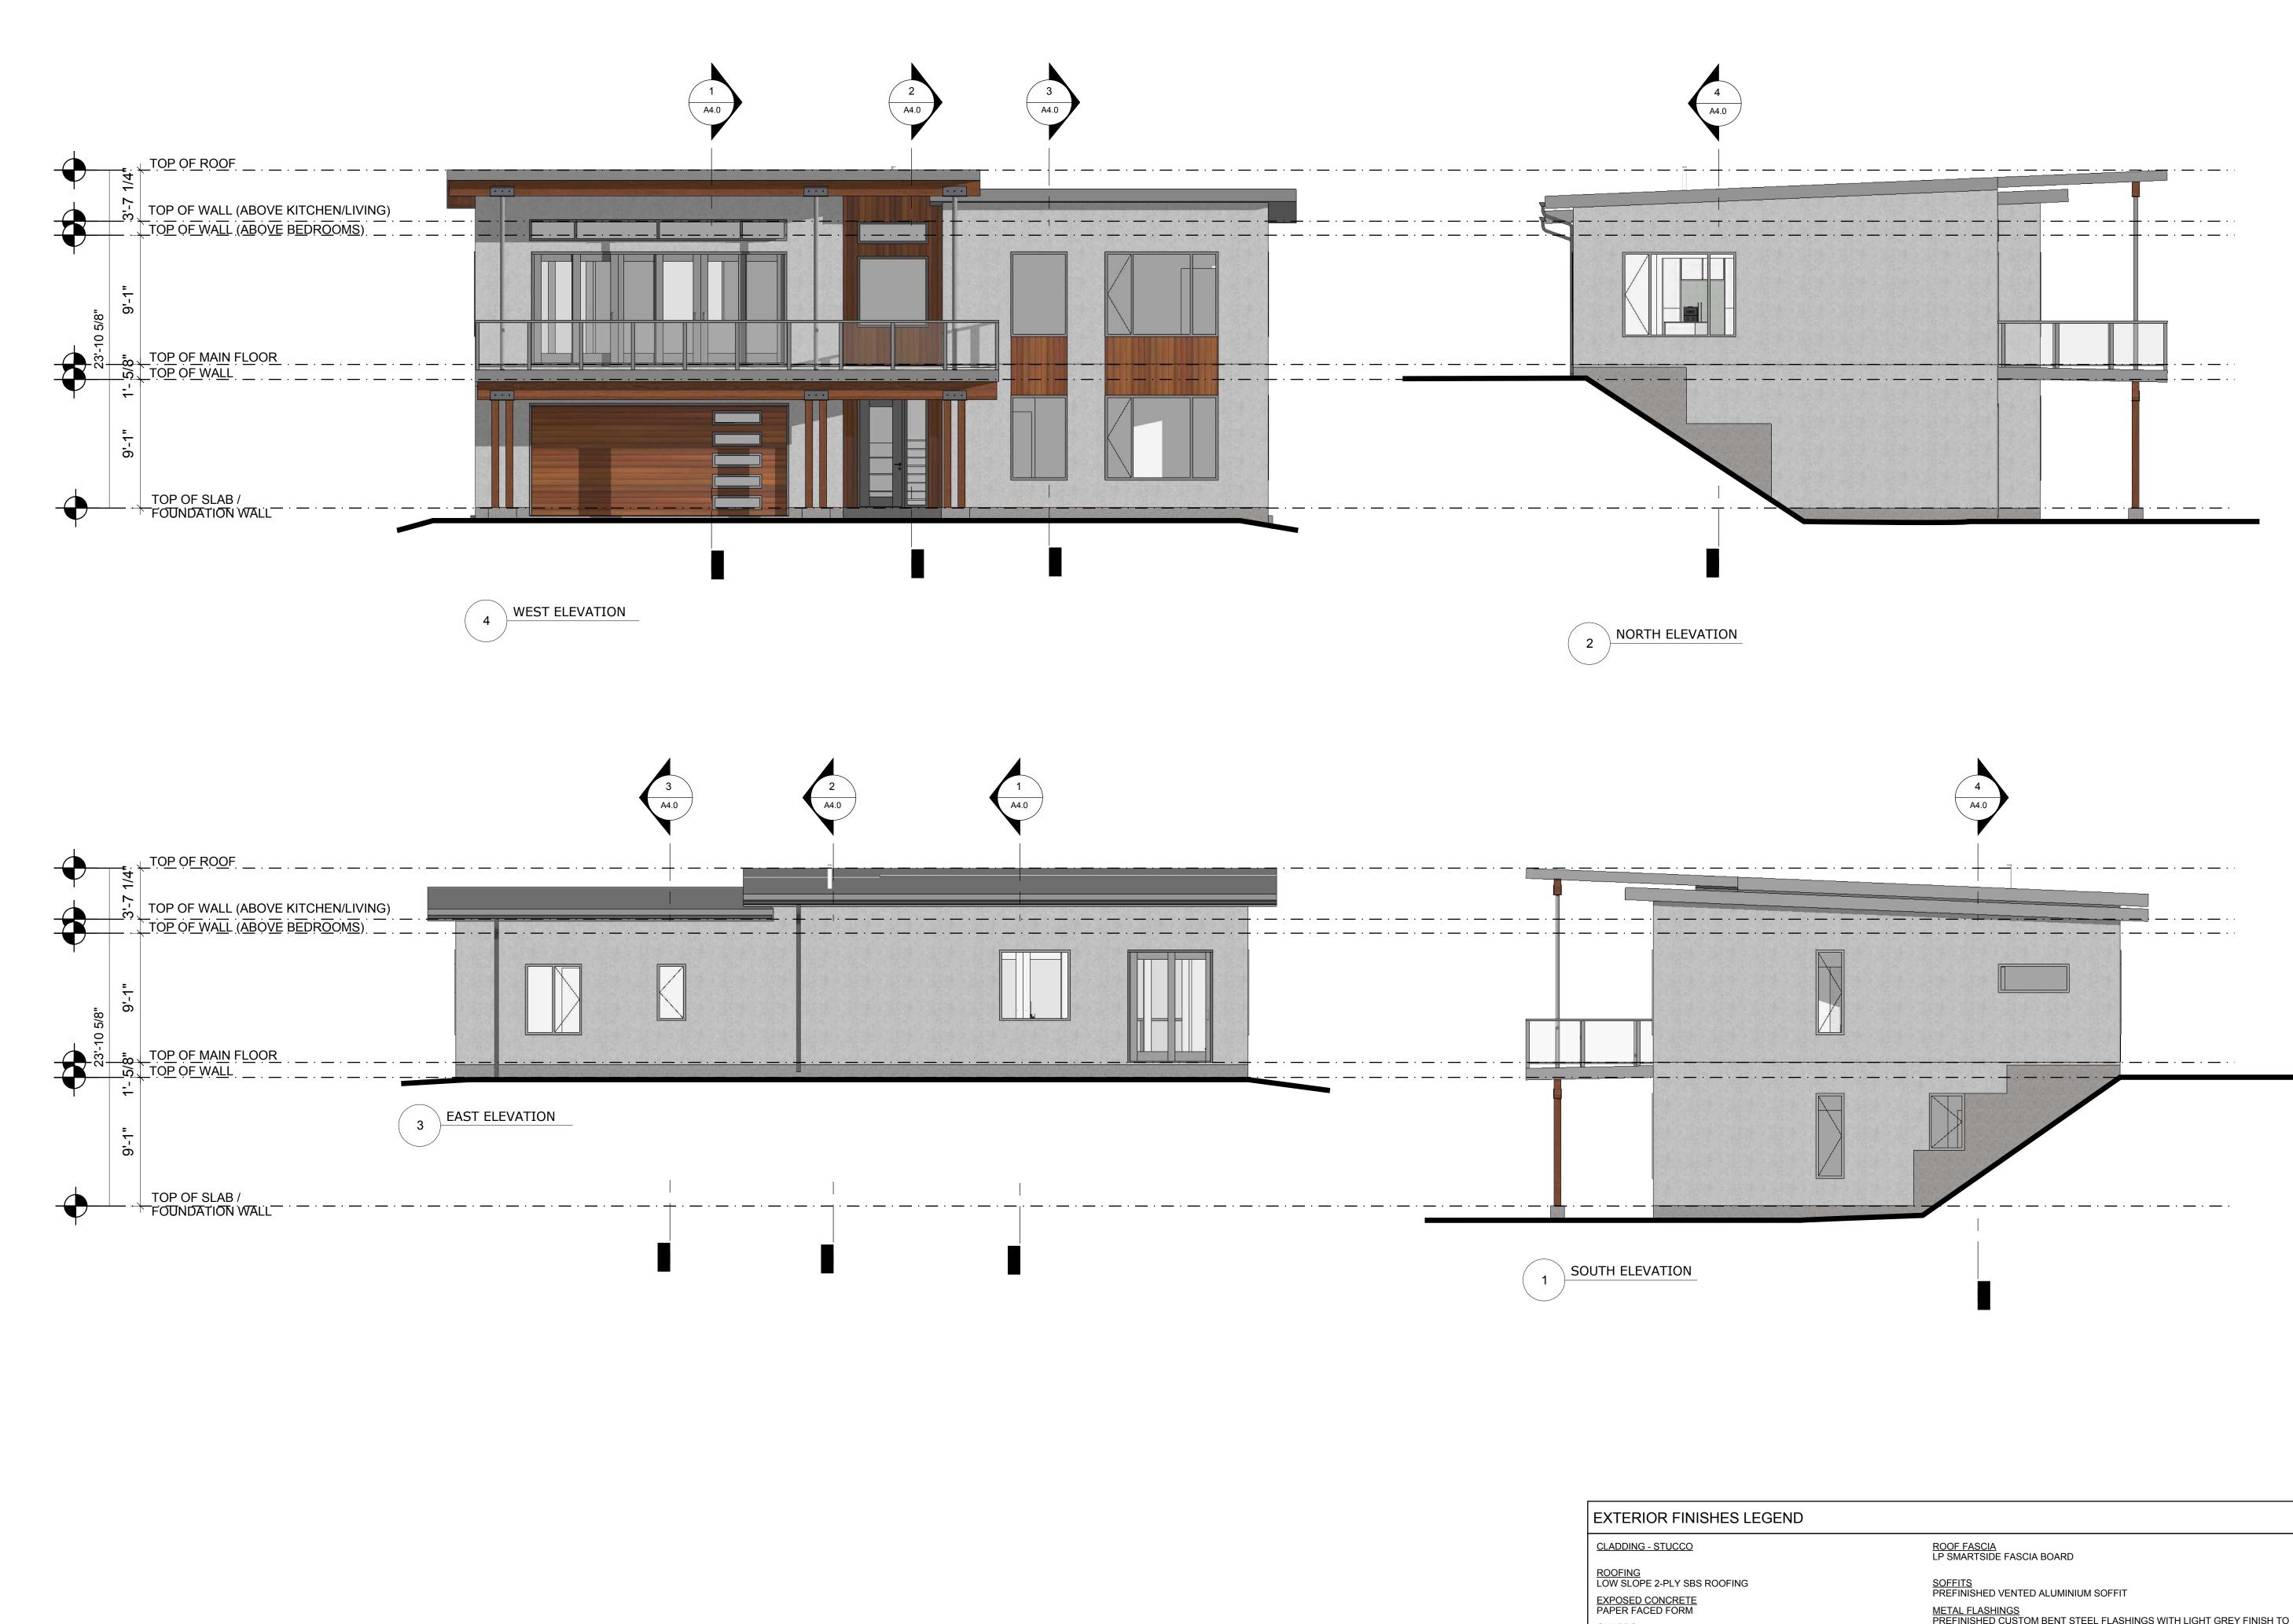
Naramata, BC

SHEET TITLE

Main & Upper Floor Plans

SCALE 1/4" = 1'-0" & 1/8" = 1'-0" DRAWING NUMBER



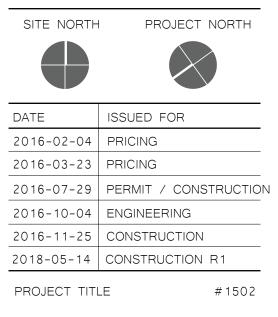

GUARDS 3'-6" TALL ALUMINUM GUARDS WITH TEMPERED GLASS PANEL INSERTS, TOP MOUNTED - GREY TO MATCH FASCIA



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<u>METAL FLASHINGS</u> PREFINISHED CUSTOM BENT STEEL FLASHINGS WITH LIGHT GREY FINISH TO MATCH WINDOWS, END DAMS ON ALL WINDOWS/DOORS

GENERAL CONDITIONS

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SITE NORTH PROJECT NORTH

DATE ISSUED FOR 2016-02-04 PRICING 2016-03-23 PRICING 2016-07-29 PERMIT / CONSTRUCTION 2016-10-04 ENGINEERING 2016-11-25 CONSTRUCTION 2018-05-14 CONSTRUCTION R1 PROJECT TITLE

#1502

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Naramata, BC

SHEET TITLE

Building Elevations

3/16" = 1'-0" SCALE DRAWING NUMBER









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2016-10-04	ENGINEERING
2016-11-25	CONSTRUCTION
2018-05-14	CONSTRUCTION R1
PROJECT TIT	LE #1502

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2880 Outlook Way, Lot 20 Naramata, BC

SHEET TITLE


Building Perspective Elevations

SCALE

N.T.S.

DRAWING NUMBER

A3.1

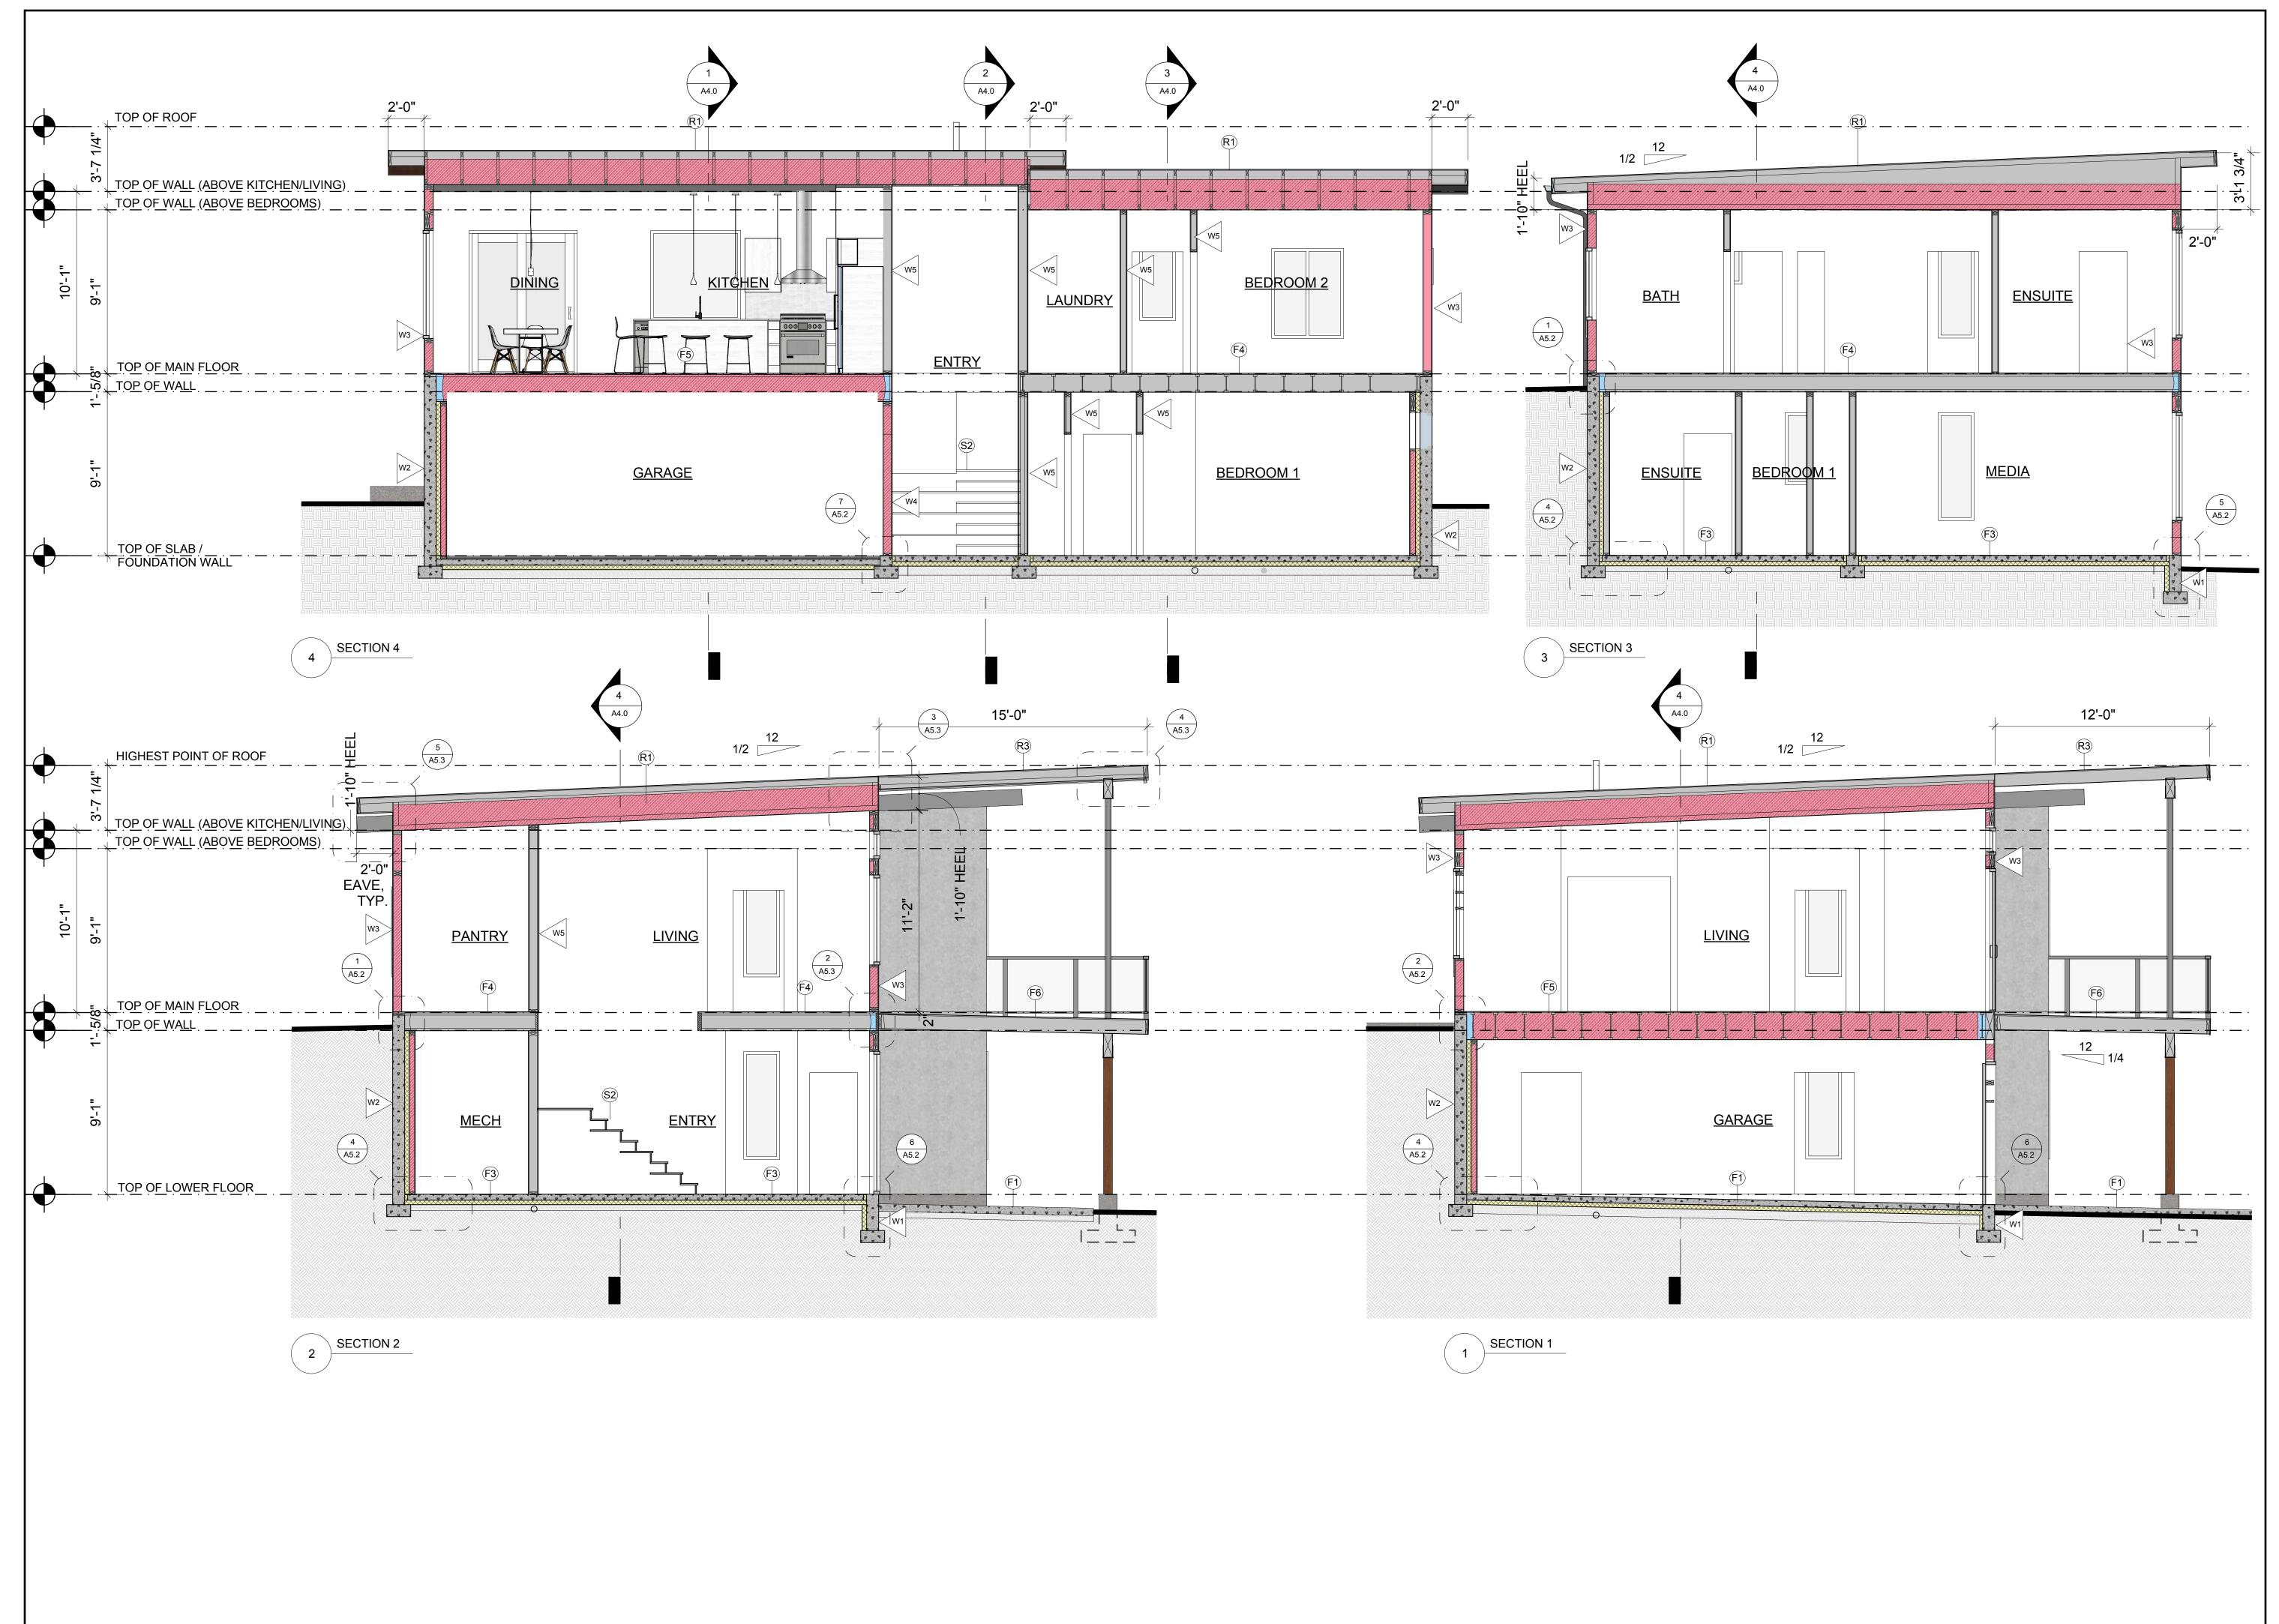

NIDO Design Inc.

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SITE NORTH PROJECT NORTH

DATE	ISSUED FOR
2016-02-04	PRICING
2016-03-23	PRICING
2016-07-29	PERMIT / CONSTRUCTION
2016-10-04	ENGINEERING
2016-11-25	CONSTRUCTION
2018-05-13	CONSTRUCTION R1
PROJECT TITI	_E #1502

Show Home


2880 Outlook Way, Lot 20 Naramata, BC

SHEET TITLE

2D Building Sections

SCALE DRAWING NUMBER 1/4" = 1'-0"



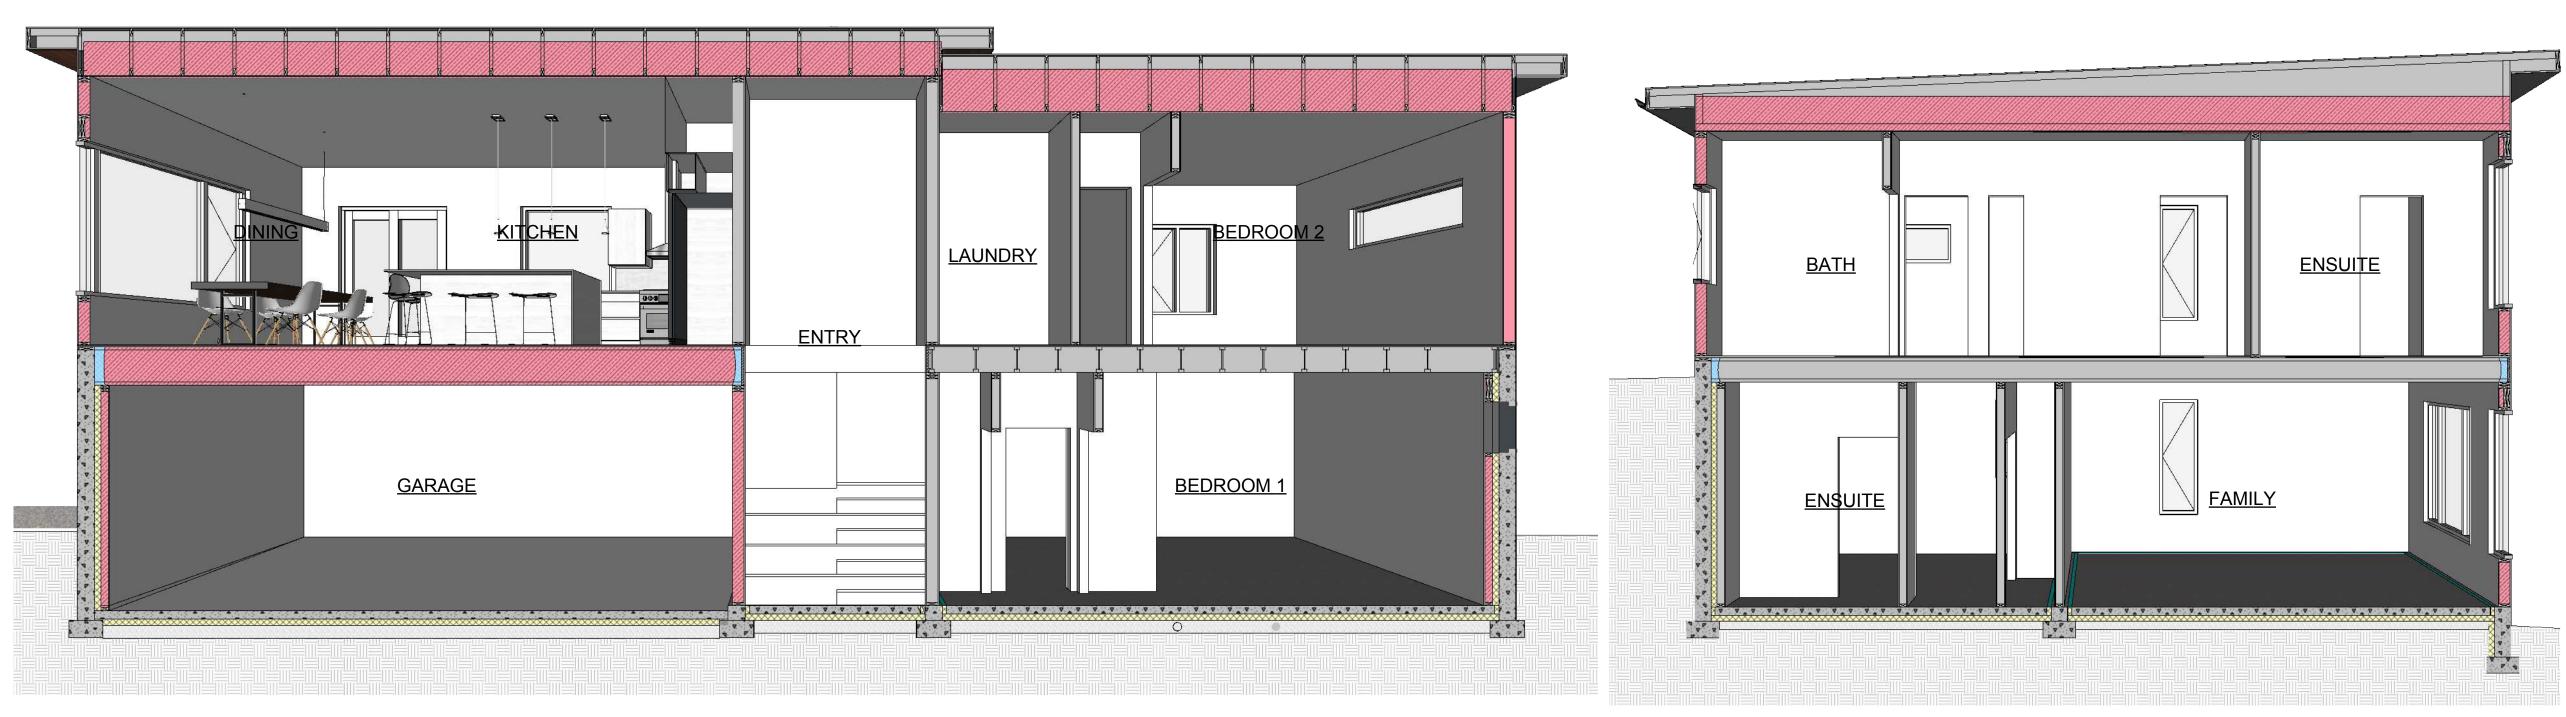

4 SECTION 4









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SITE NORTH PROJECT NORTH

DATE	ISSUED FOR
2016-02-04	PRICING
2016-03-23	PRICING
2016-07-29	PERMIT / CONSTRUCTION
2016-10-04	ENGINEERING
2016-11-25	CONSTRUCTION
2018-05-13	CONSTRUCTION R1
PROJECT TITLE #1502	

#1502

Show Home 2880 Outlook Way, Lot 20

Naramata, BC

SHEET TITLE


SCALE


3D Building Sections

DRAWING NUMBER


N.T.S.


A4

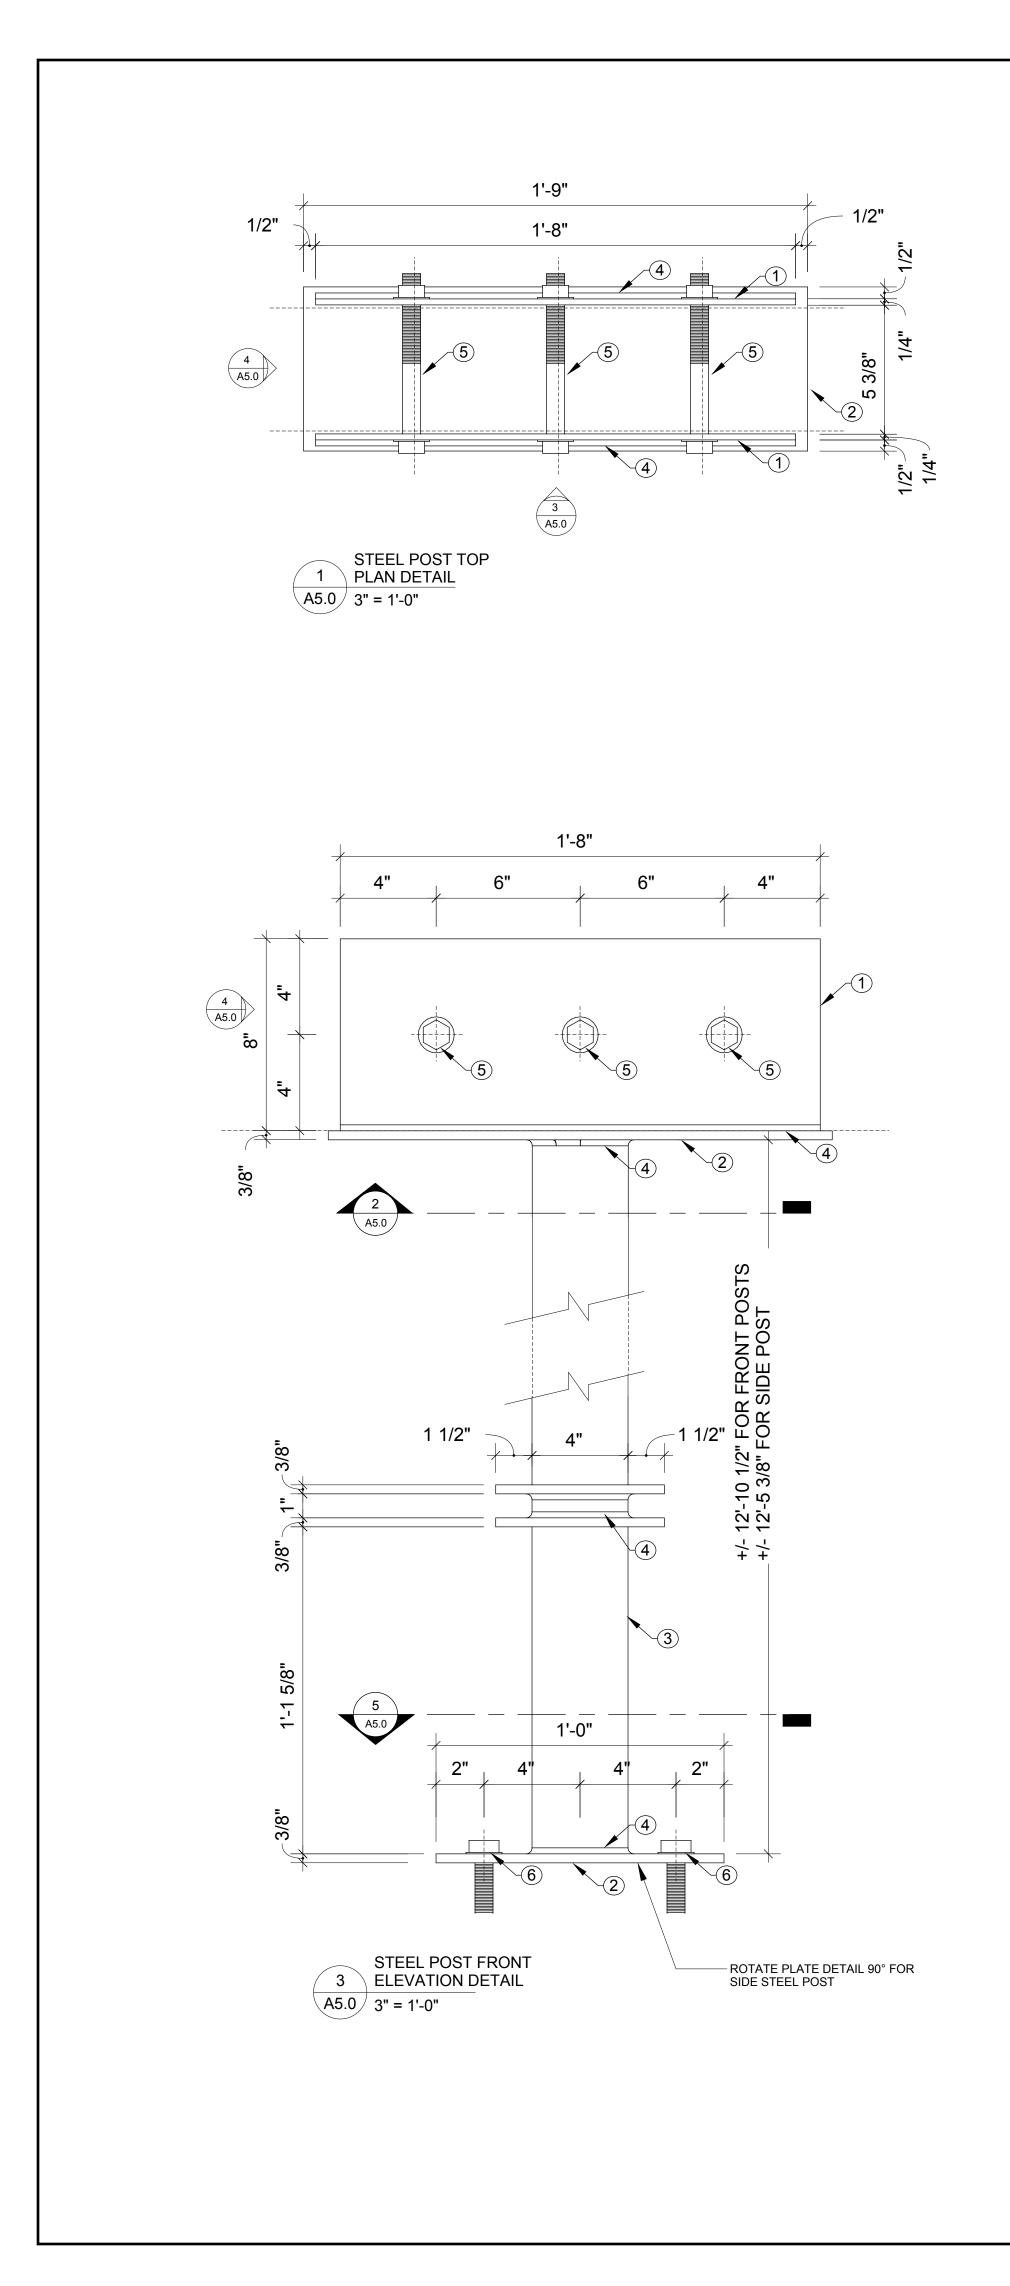


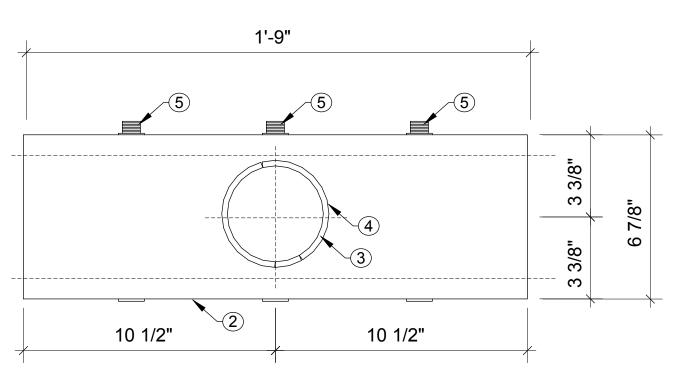




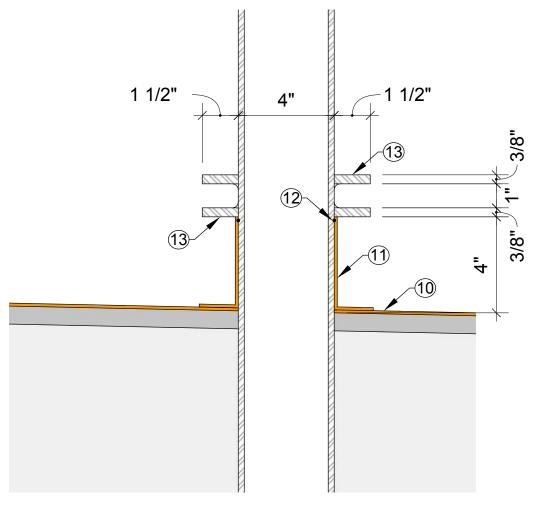

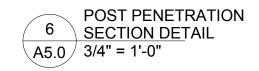


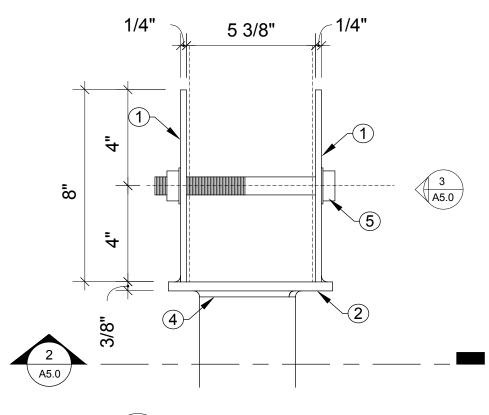


4 STEEL POST TOP SIDE A5.0 ELEVATION DETAIL

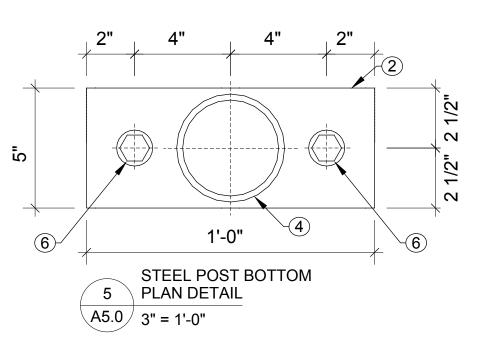

TAPERED WOOD BLOCKING TO CREATE 2% SLOPE -

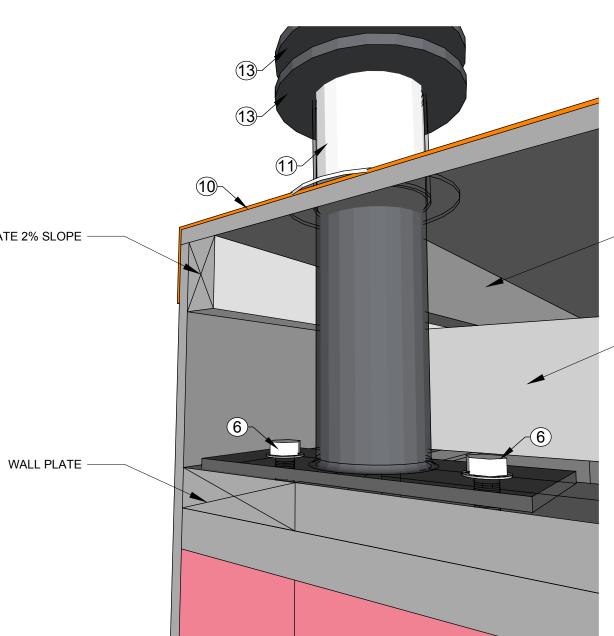

7 SIDE POST PENETRATION 7 <u>PERSPECTIV</u>E SECTION DETAIL A5.0 N.T.S.

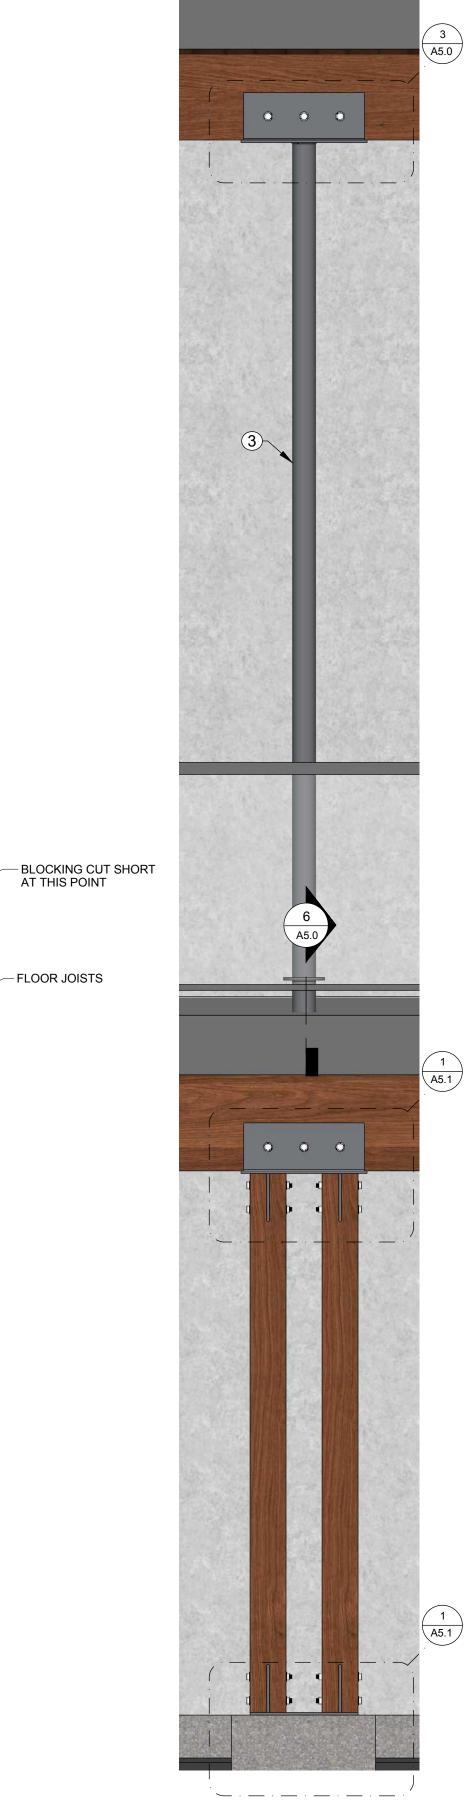

- FLOOR JOISTS

6 WHOLE POST ELEVATIONA5.0 3/4" = 1'-0"

250.448.4307 hello@nido.design DETAIL KEYNOTES 1) 1/4" STEEL PLATE 2 3/8" STEEL PLATE (3) 4" DIA. X 1/4" HSS STEEL COLUMN (4) 1/4" FILLET WELD 5 3/4" DIA. BOLT WASHERS & NUTS (6) 3/4" DIA. X 8" LAG SCREW (7) 6" X 6" WOOD POST 8 3/4" DIA. X 8" THREADED ROD (9) CONCRETE FOUNDATION (10) DECK MEMBRANE (11) MEMBRANE COLLAR 12 TOP COLLAR SEALED IN CONTINUOUS SEALENT BEAD (13) 7" DIA. 3/8 THICK STEEL PLATE WEATHER CAP (14) MOISTURE MEDIUM

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Kelowna, BC, V1Y 6L2

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SITE NORTH PROJECT NORTH

DATE ISSUED FOR 2016-11-25 CONSTRUCTION 2018-05-14 CONSTRUCTION R1 PROJECT TITLE #1502

Show Home 2880 Outlook Way, Lot 20

Naramata, BC

SHEET TITLE


Steel Post Details


DRAWING NUMBER


SCALE

SEE DRAWING



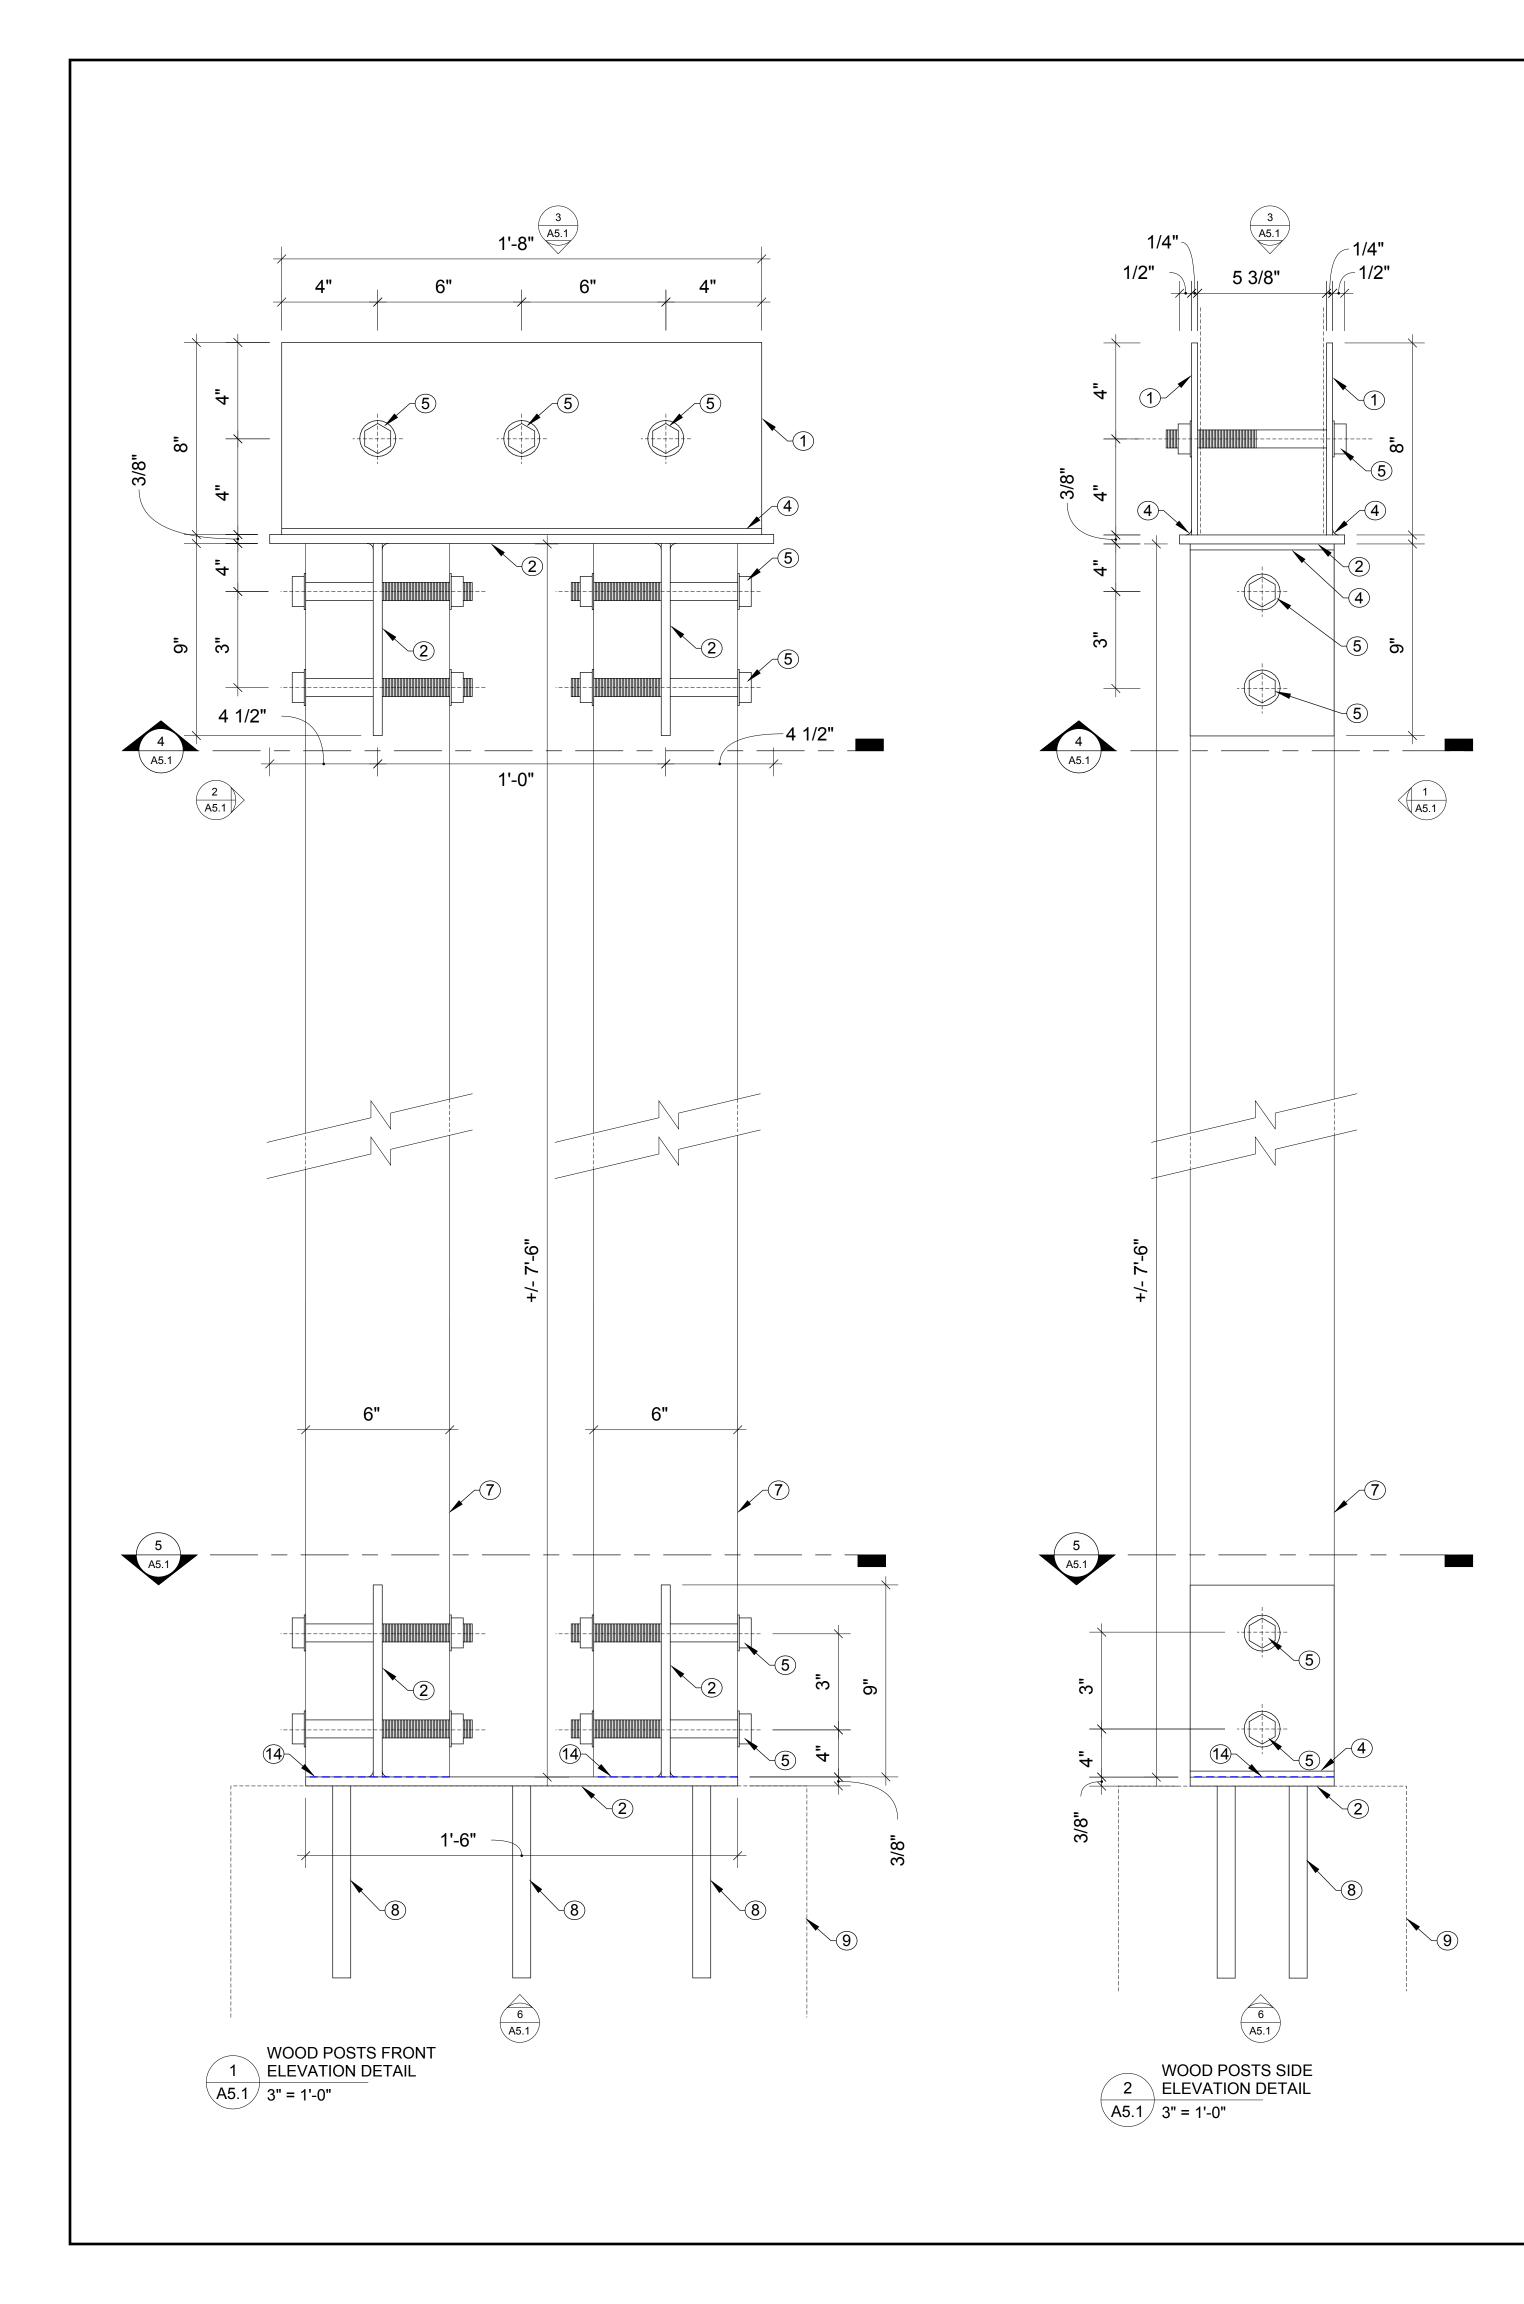

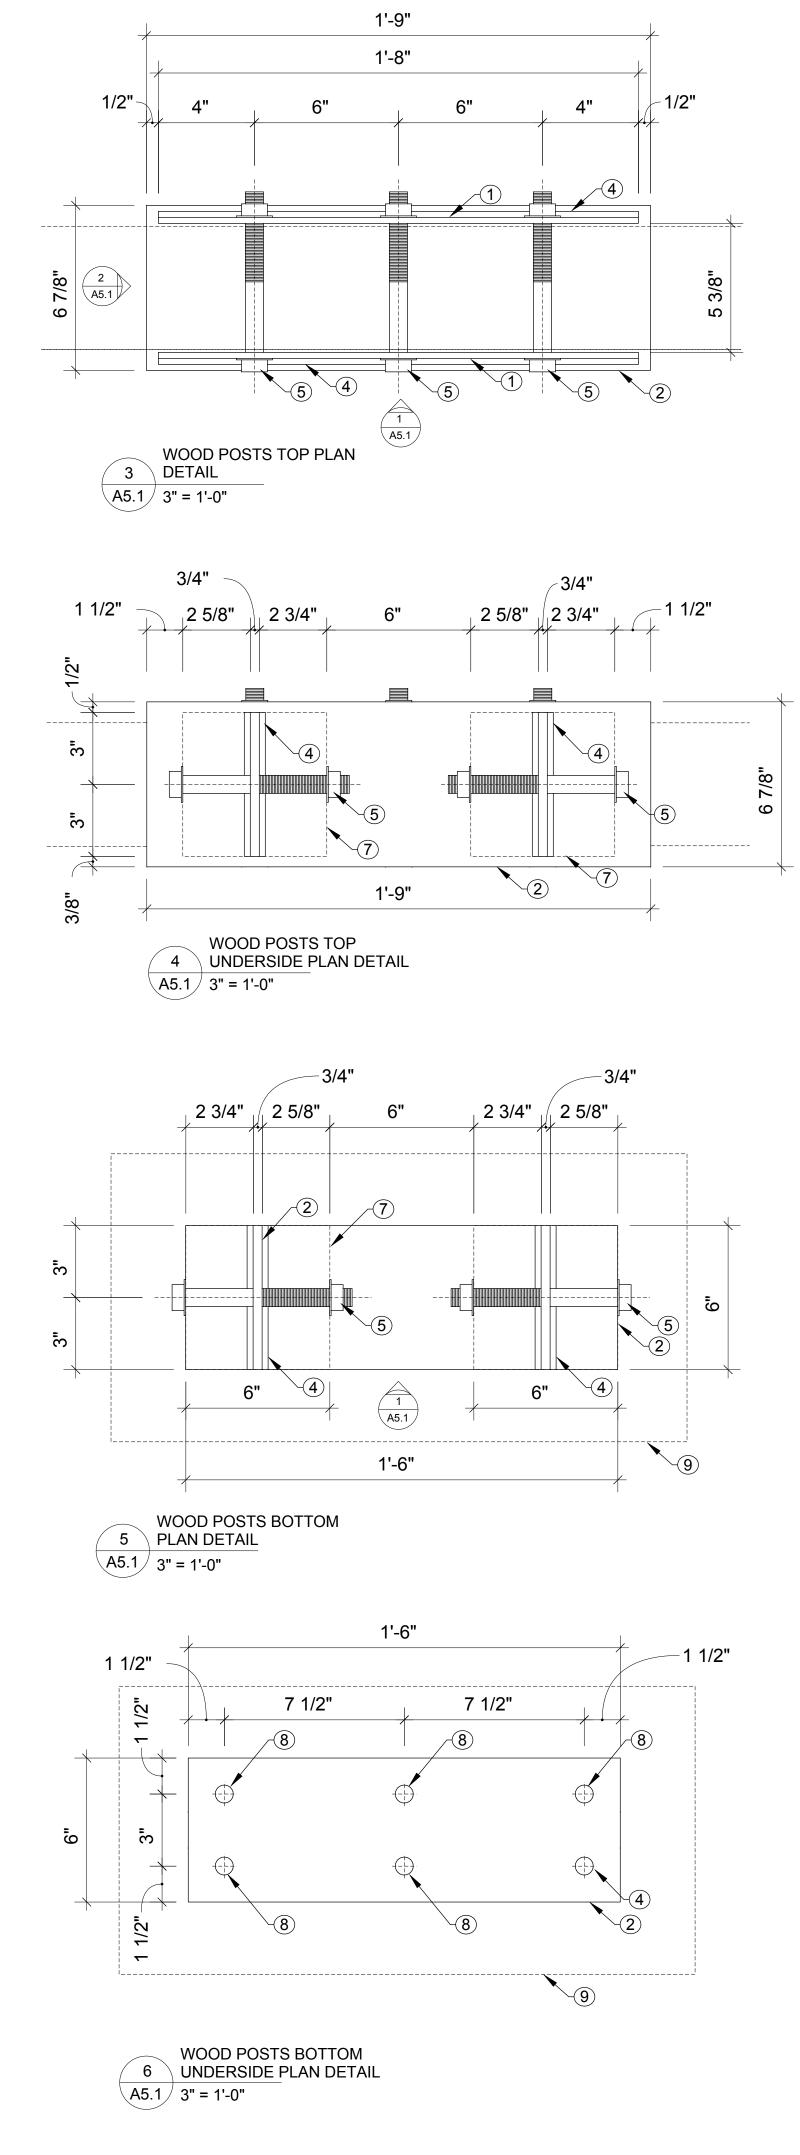

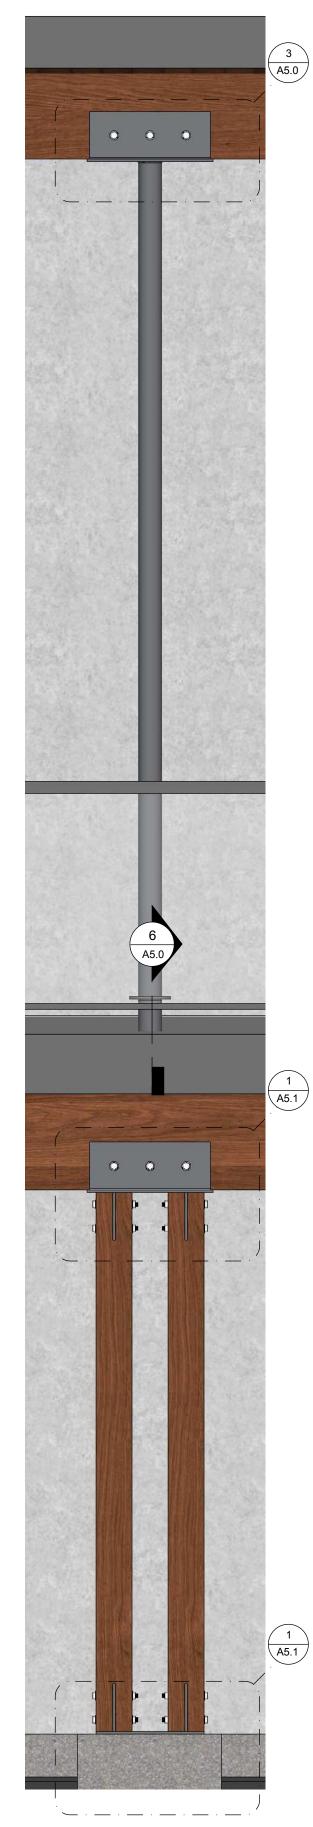

 $\begin{array}{r} \hline 7 \\ \hline \text{WHOLE POST ELEVATION} \\ \hline \text{A5.1} \\ \hline 3/4" = 1'-0" \end{array}$

NIDO

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DET	AIL KEYNOTES
1	1/4" STEEL PLATE
2	3/8" STEEL PLATE
3	4" DIA. X 1/4" HSS STEEL COLUMN
4	1/4" FILLET WELD
5	3/4" DIA. BOLT WASHERS 8 NUTS
6	3/4" DIA. X 8" LAG SCREW
7	6" X 6" WOOD POST
8	3/4" DIA. X 8" THREADED ROD
9	CONCRETE FOUNDATION
10	DECK MEMBRANE
(11)	MEMBRANE COLLAR
(12)	TOP COLLAR SEALED IN CONTINUOUS SEALENT BEAD
13	7" DIA. 3/8 THICK STEEL PLATE WEATHER CAP
(14)	MOISTURE MEDIUM

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SITE NORTH	PROJECT NORTH

DATE ISSUED FOR 2016-11-25 CONSTRUCTION 2018-05-14 CONSTRUCTION R1 PROJECT TITLE #1502


Show Home 2880 Outlook Way, Lot 20 Naramata, BC


SHEET TITLE


Front Wood Post

Details SEE DRAWING SCALE DRAWING NUMBER

A5.1

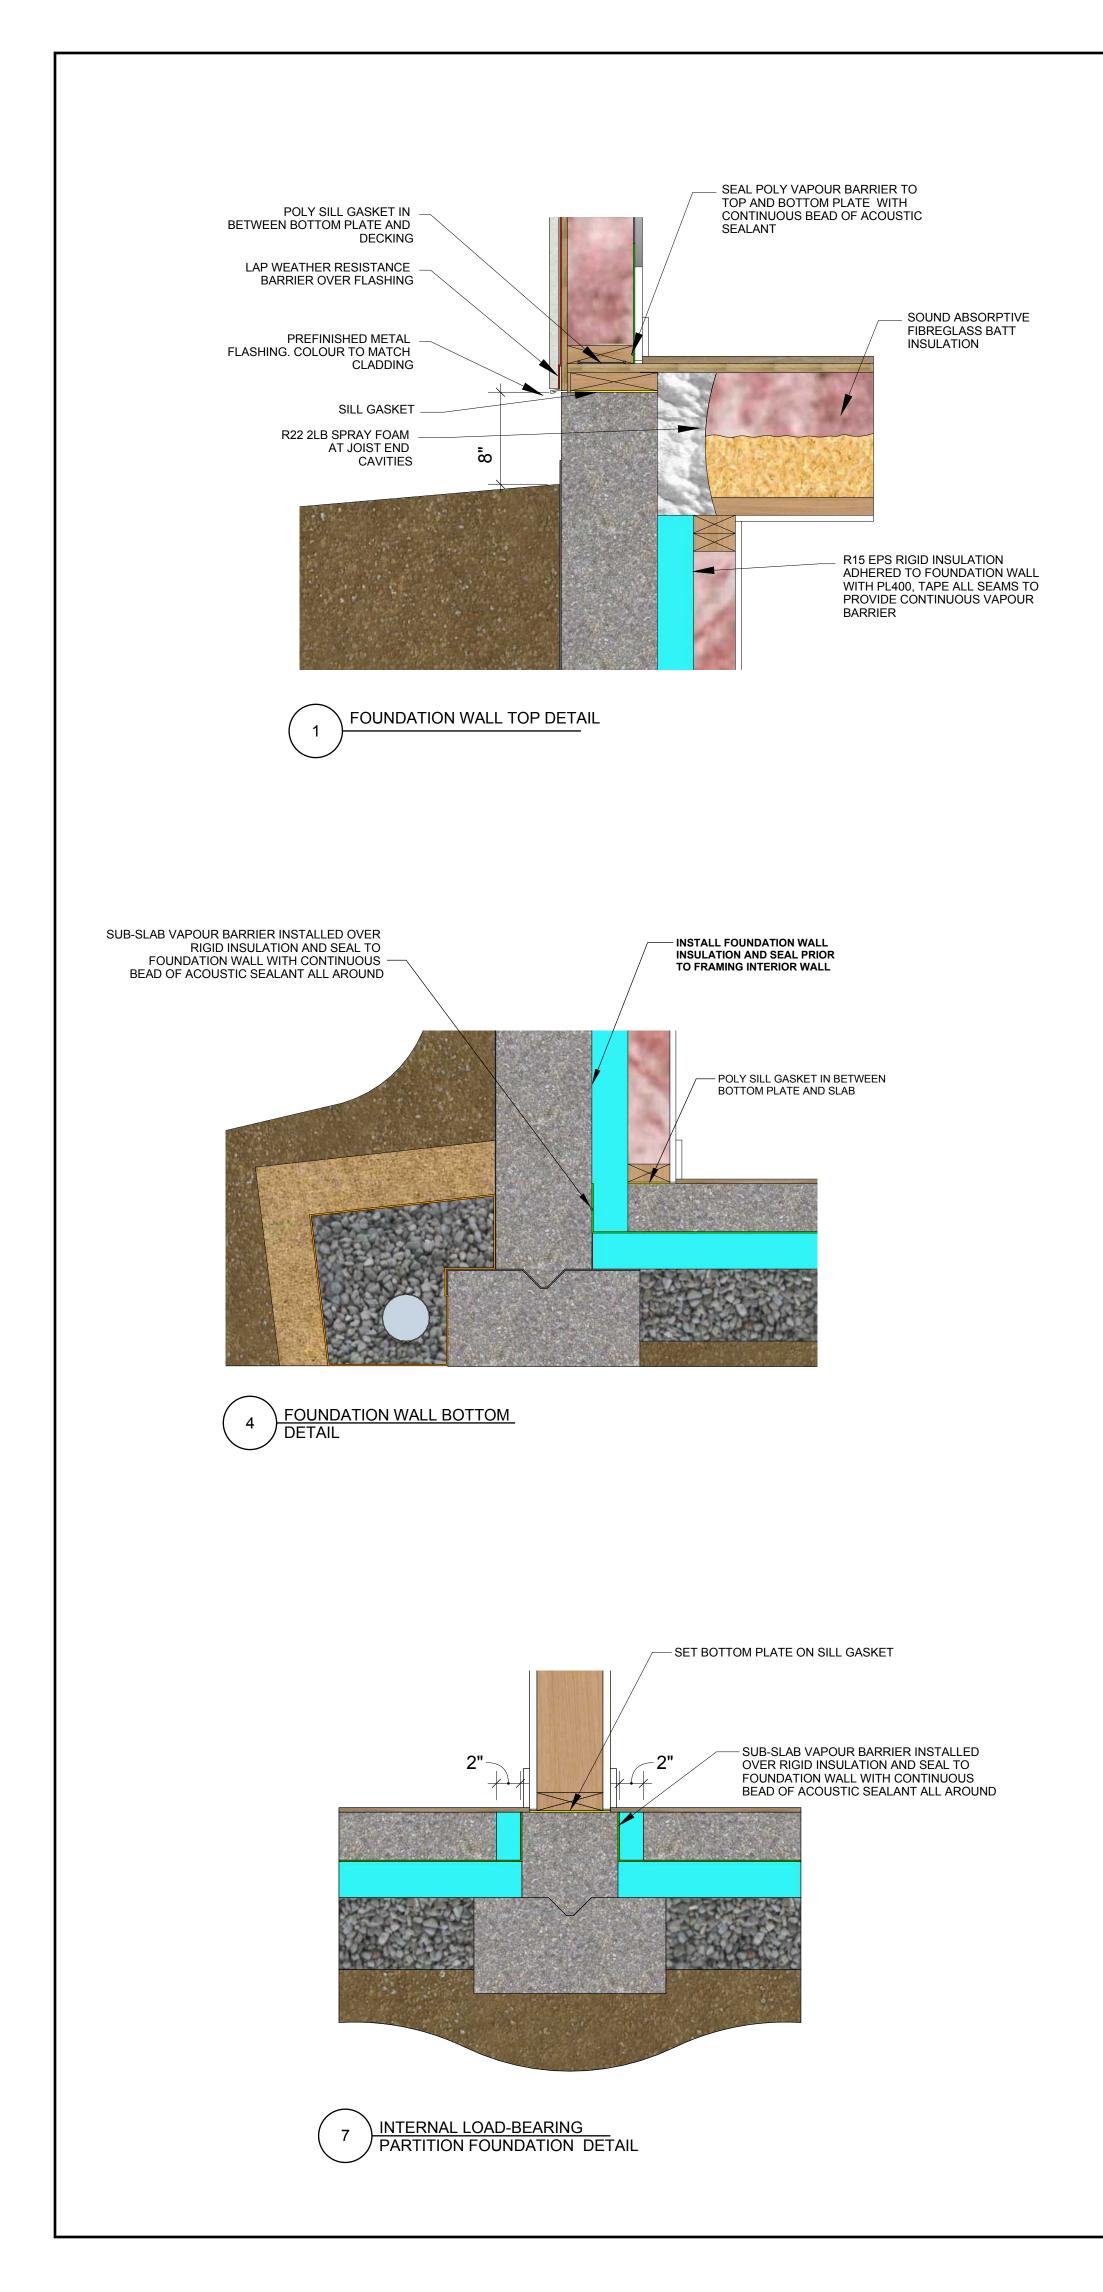

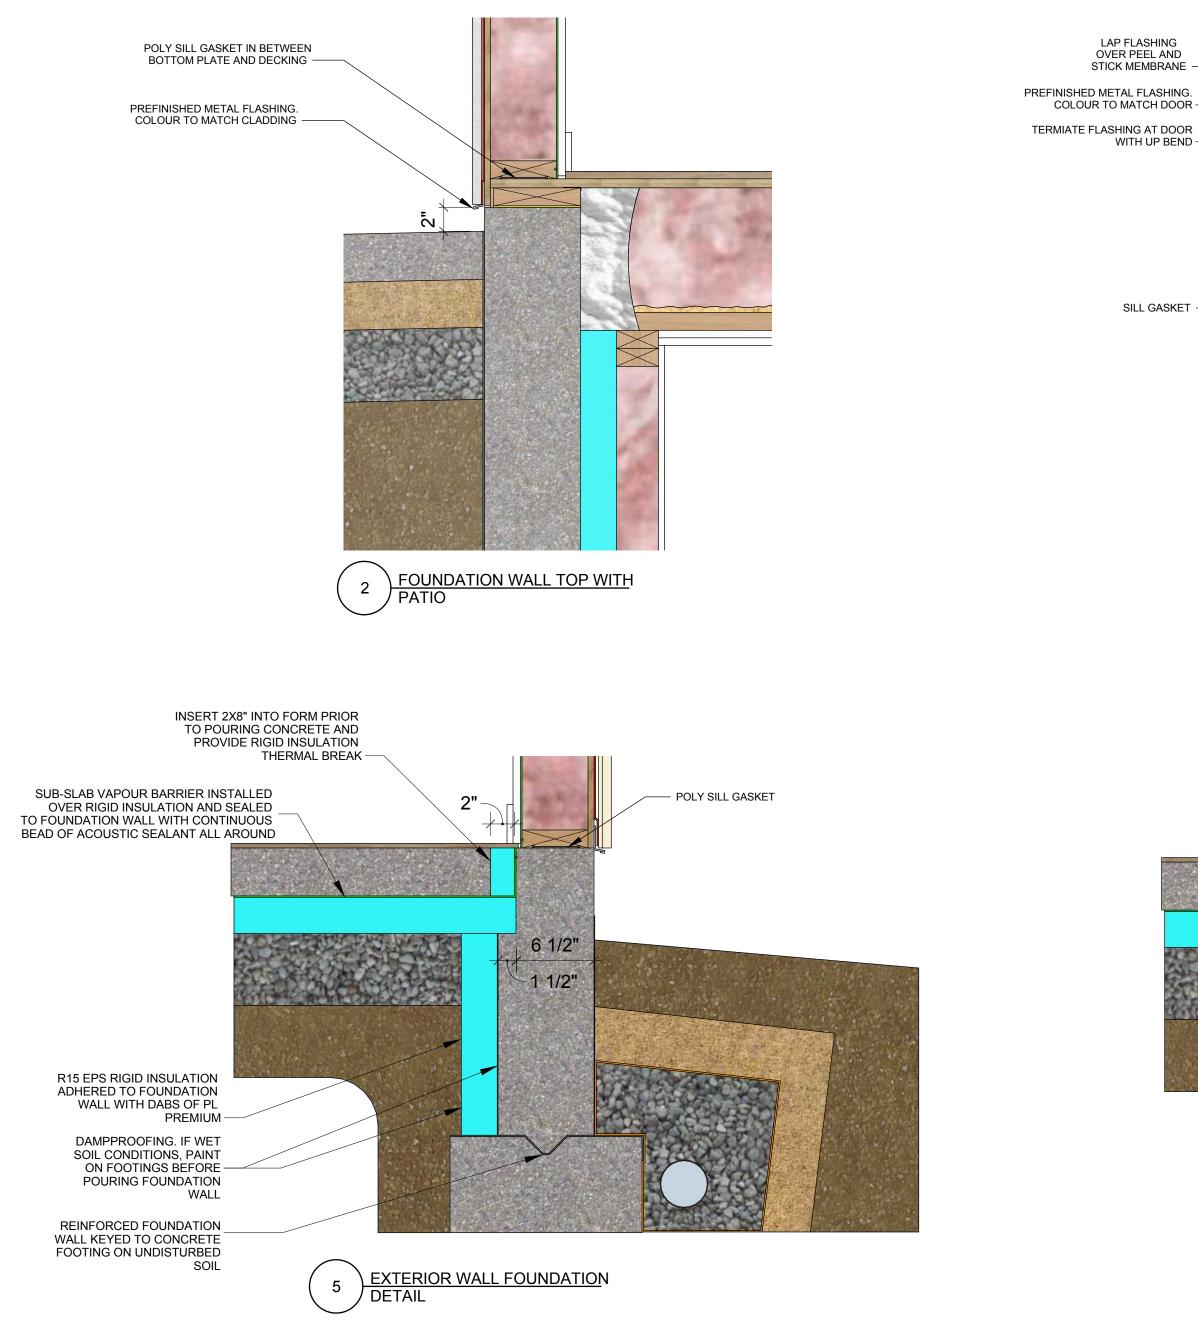

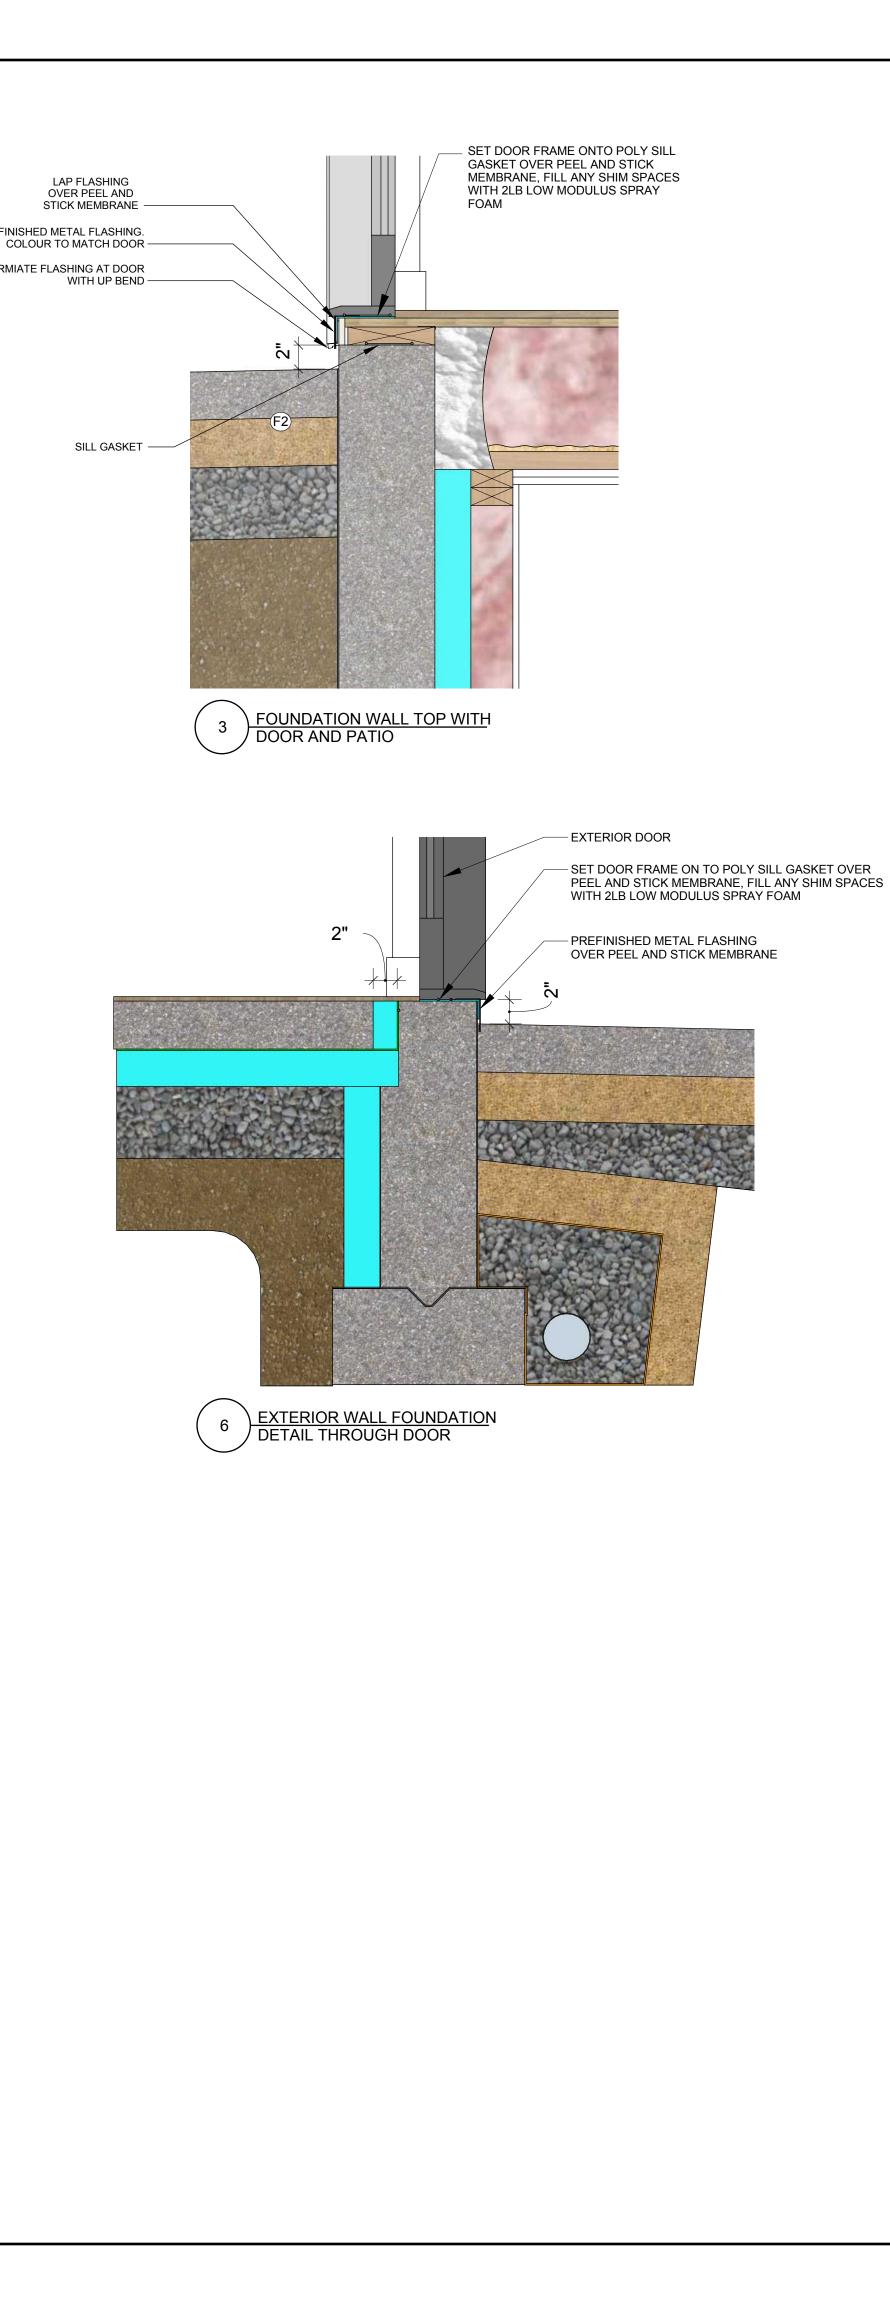

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ITE	NORTH	PROJECT	NORTH	
	NORTH	INCOLOI		

DATE	ISSUED FOR
2016-11-25	CONSTRUCTION
2018-05-14	CONSTRUCTION R1
	<u> </u>

PROJECT TITLE

#1502

Show Home 2880 Outlook Way, Lot 20


Naramata, BC


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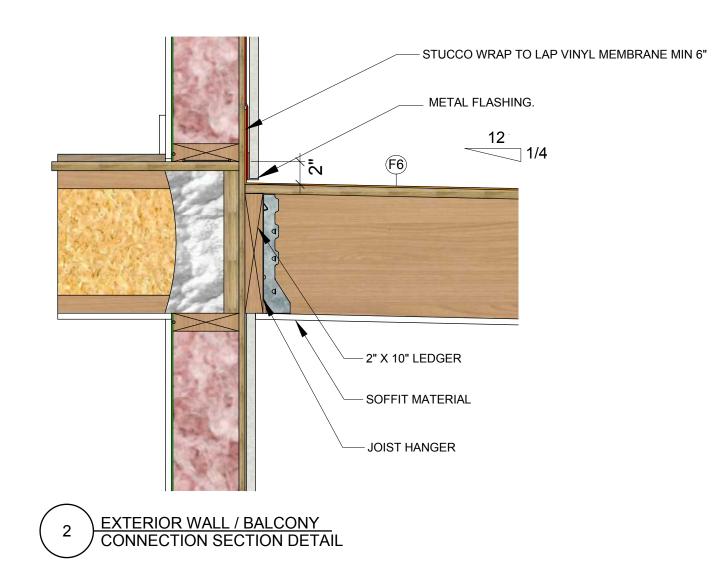
House Details


 SCALE
 1
 1/2" = 1'-0"

 DRAWING NUMBER




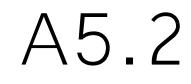

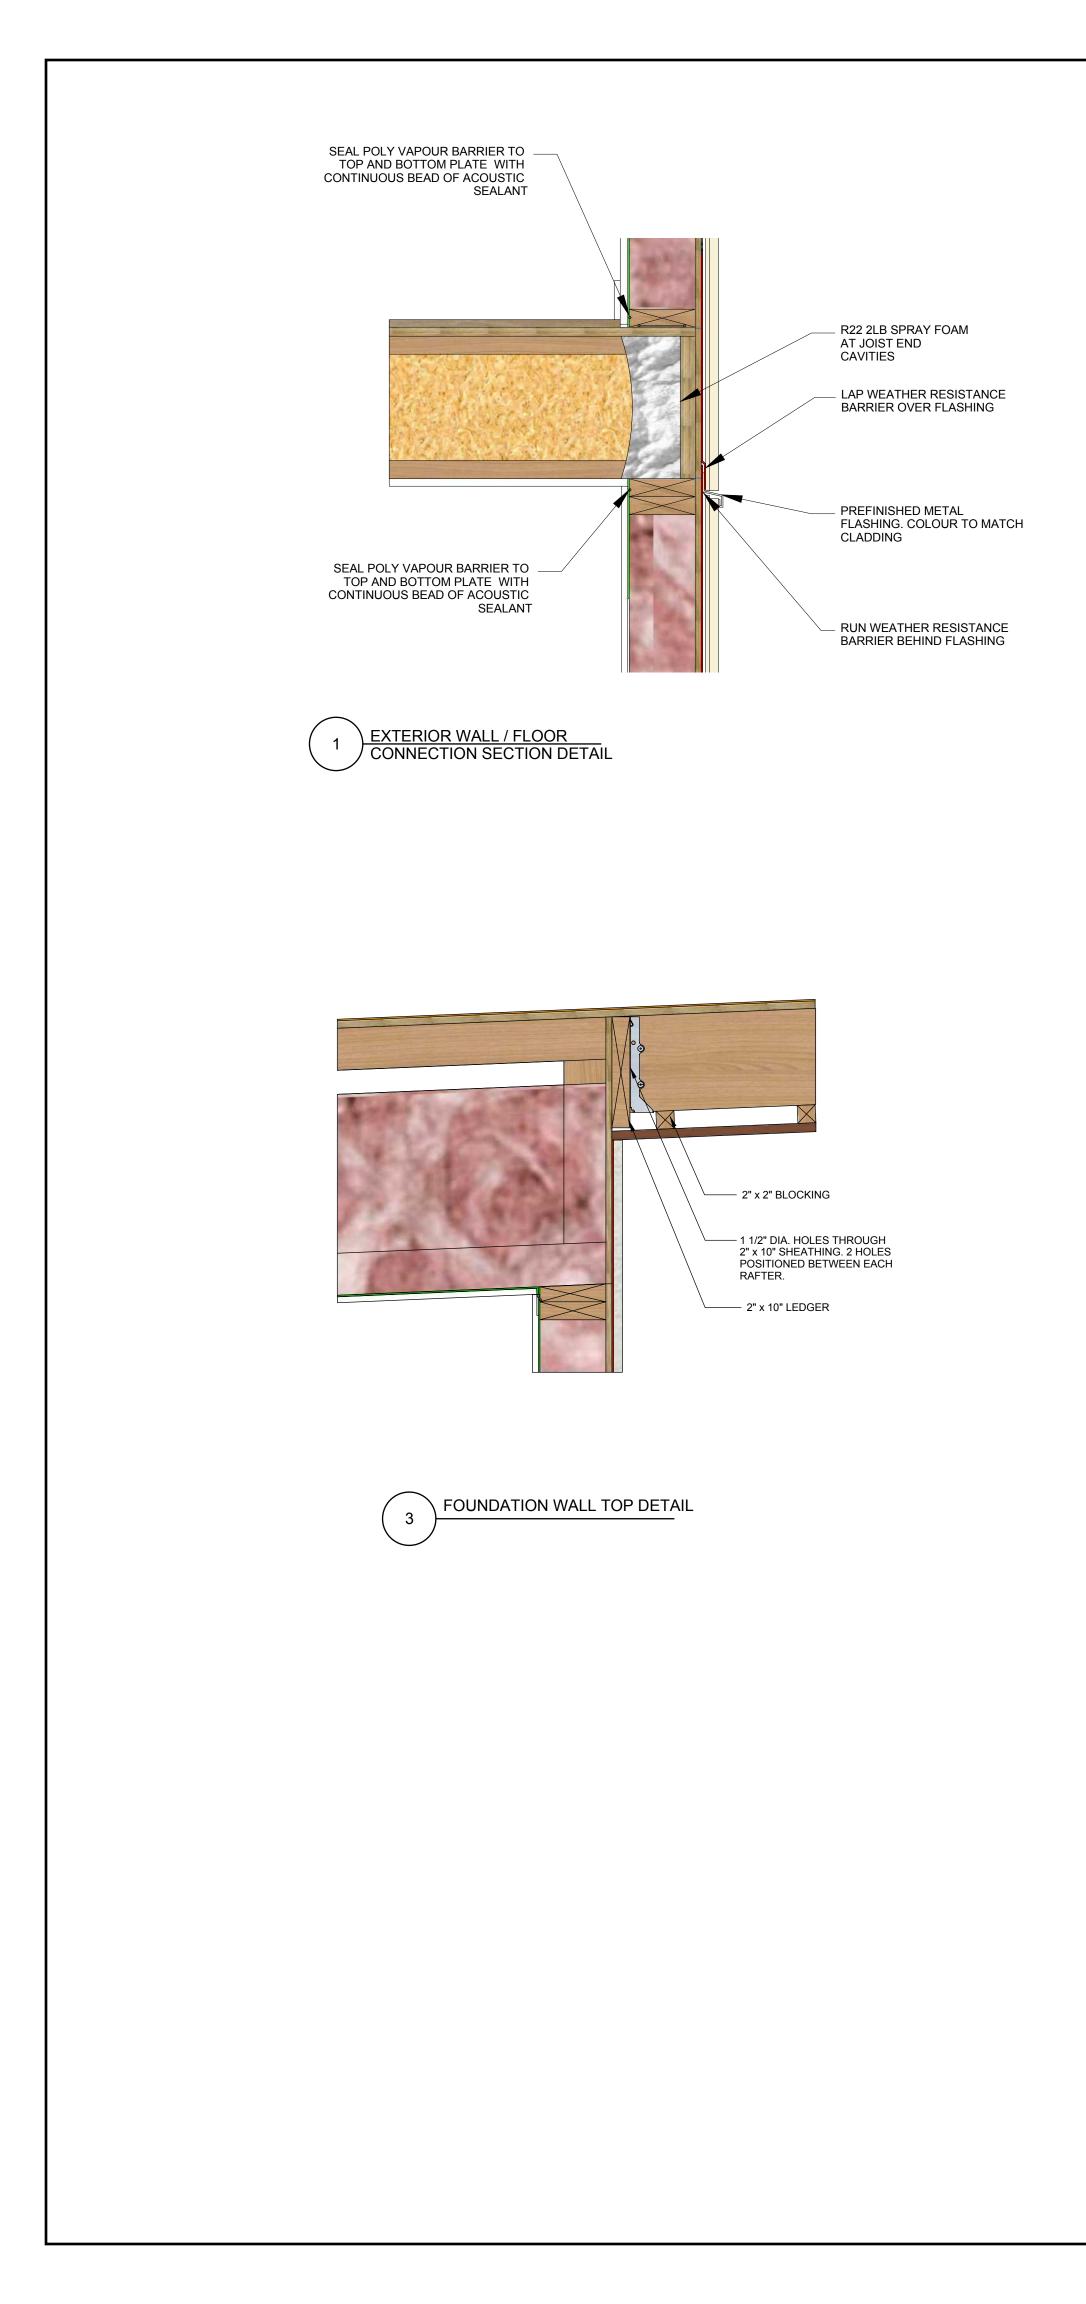

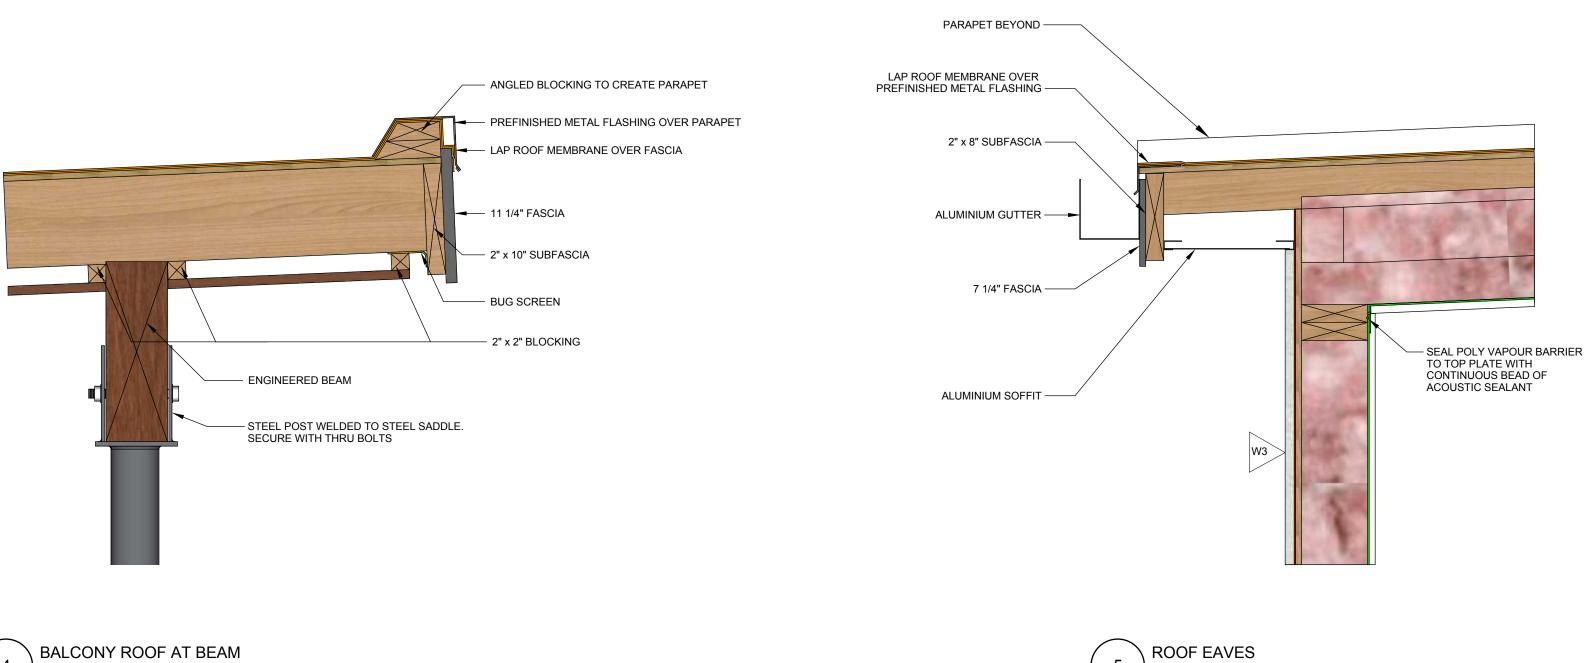

5

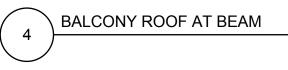



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SITE NORTH	PROJECT NORTH

DATE	ISSUED FOR
2016-11-25	CONSTRUCTION
2018-05-14	CONSTRUCTION R1

PROJECT TITLE


#1502


Show Home 2880 Outlook Way, Lot 20 Naramata, BC


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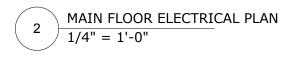
House Details

SCALE 1 1/2" = 1'-0" DRAWING NUMBER



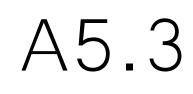

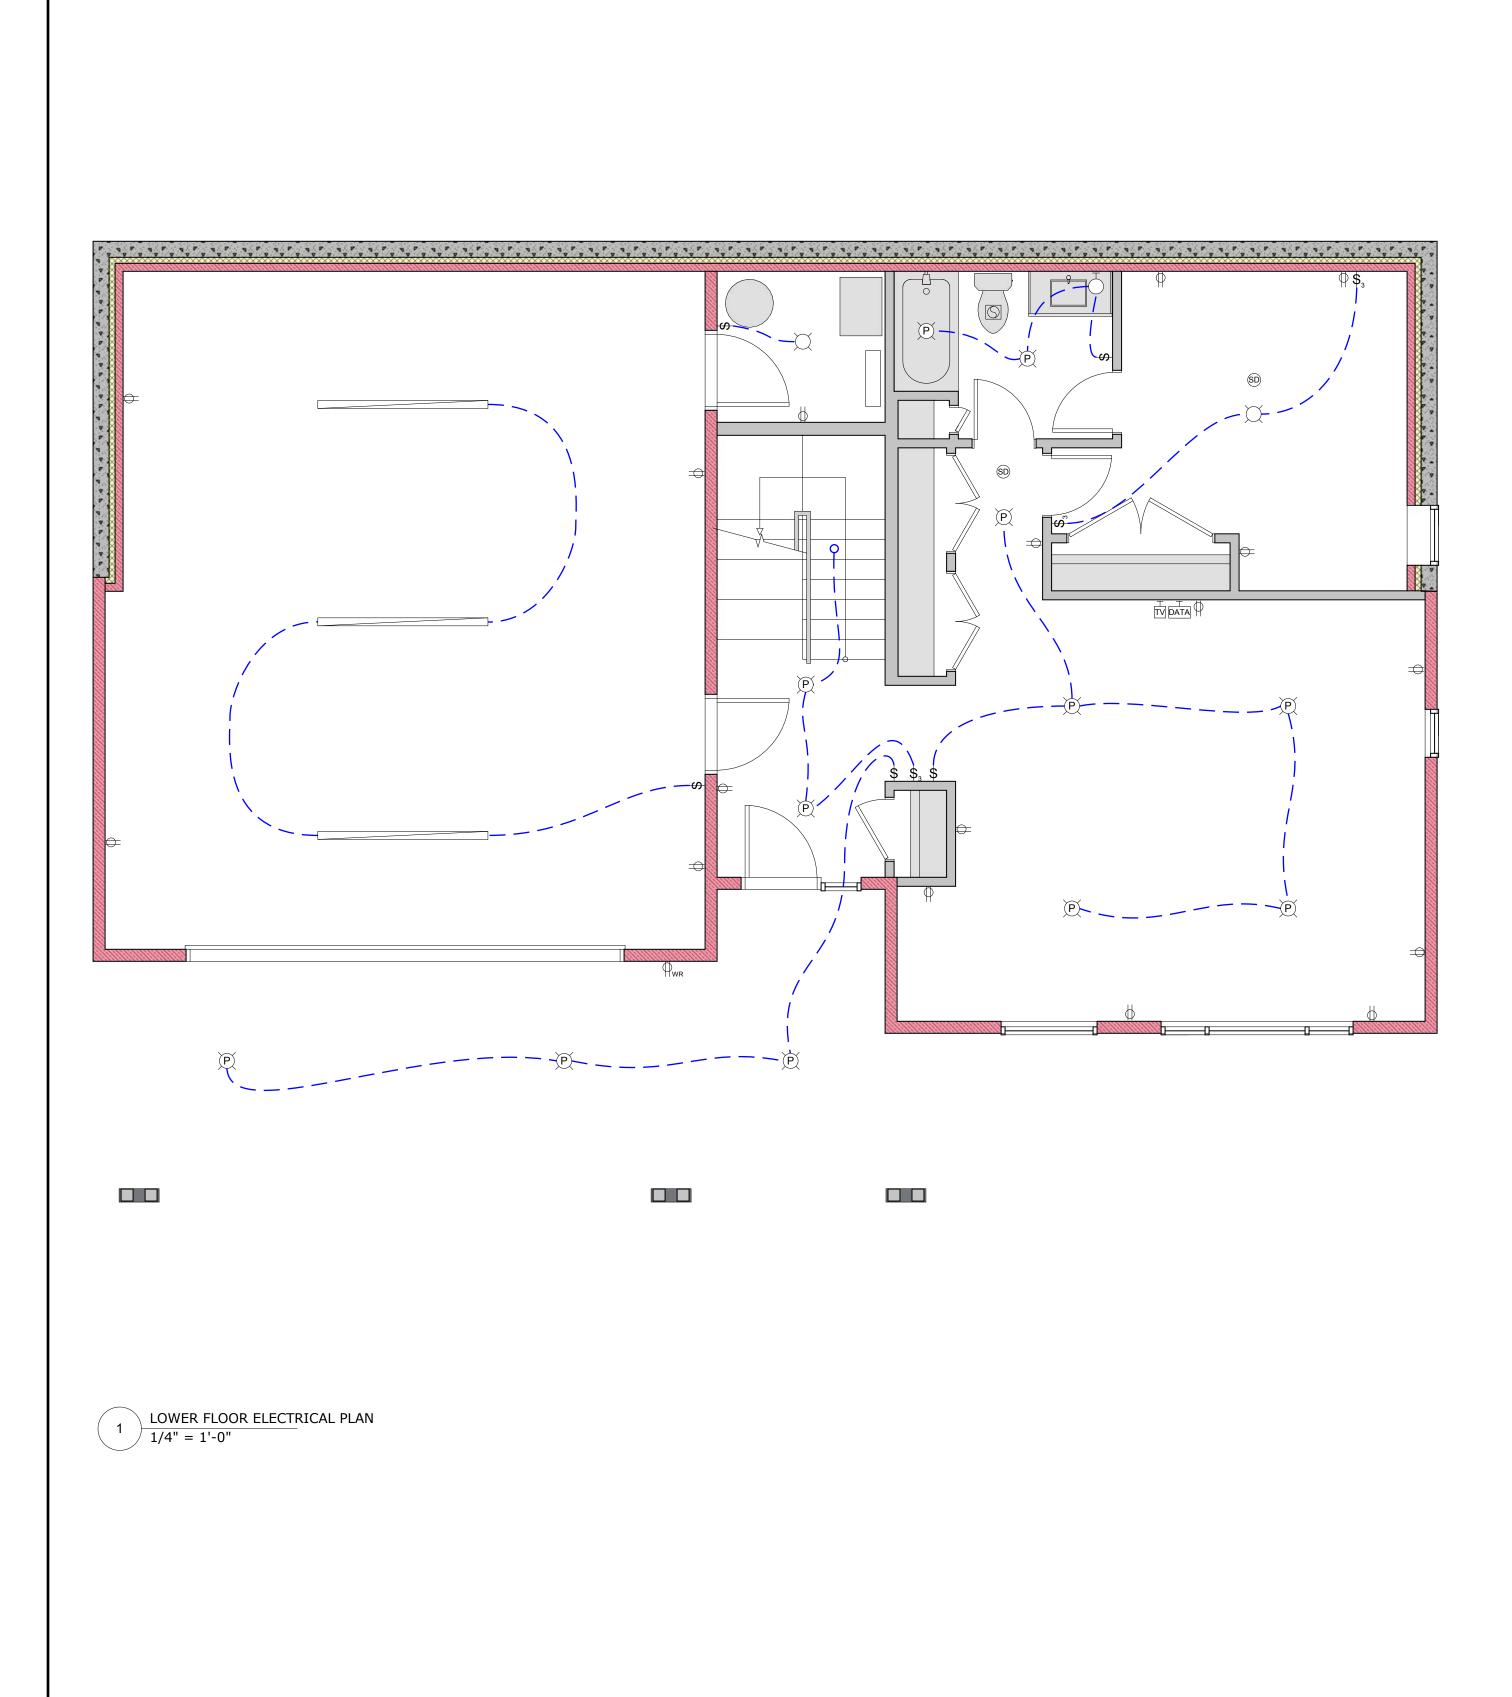

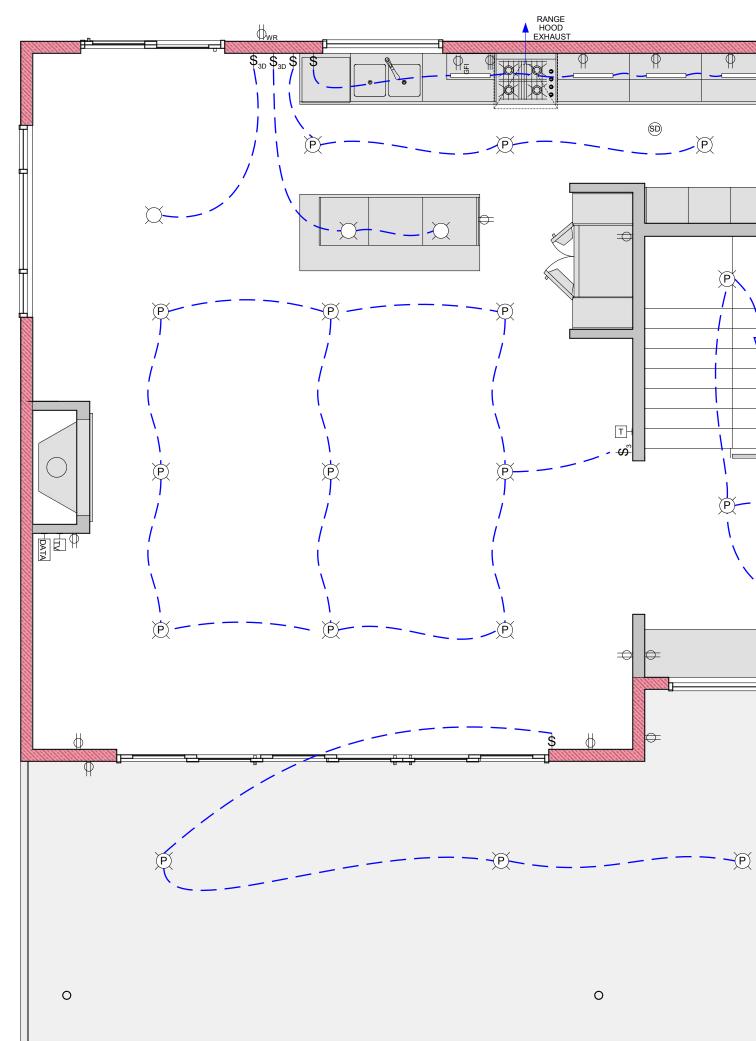

DRAWING NUMBER

1/4" = 1'-0"

F.O

#1502

Electrical Plans

SHEET TITLE

SCALE

DATE

2880 Outlook Way, Lot 20 Naramata, BC

Show Home

PROJECT TITLE

2016-10-04 ENGINEERING 2016-11-25 CONSTRUCTION 2018-05-14 CONSTRUCTION R1

2016-02-04 PRICING 2016-03-23 PRICING 2016-07-29 PERMIT / CONSTRUCTION

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PROJECT NORTH

SITE NORTH

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ELECTRICAL SYMBOLS

DUPLEX RECEPTACLE - WEATHER

CEILING MOUNTED LIGHT FIXTURE

WALL MOUNTED LIGHT FIXTURE

RECESSED LOW VOLTAGE LIGHT

UNDER CABINET LED STRIP LIGHT

120V LIGHT SWITCH WITH TIMER

DUPLEX RECEPTACLE - SOFFIT MOUNTED

DUPLEX RECEPTACLE - FLOOR MOUNTED

CEILING MOUNTED FLUORESCENT LIGHT

120V. 3-WAY LIGHT SWITCH WITH DIMMER

120V. LIGHT SWITCH WITH OCCUPANCY

RECESSED LIGHT FIXTURE + EXHAUST FAN

WALL MOUNTED EXHAUST FAN OR HRV RETURN

DUPLEX RECEPTACLE

240V. RANGE OR DRYER

RECESSED LIGHT

120V. LIGHT SWITCH

120V. 3-WAY LIGHT SWITCH

FIXTURE

SENSOR

TELEVISION CABLE

TELEPHONE OUTLET

- S DATA OUTLET (CAT6)

EXHAUST FAN

SMOKE DETECTOR

COMBO

RESISTANT

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NIDC NIDO Design Inc. 203-251 Lawrence Avenue Kelowna, BC, V1Y 6L2

250.448.4307 hello@nido.design