


HUTH CARRIAGE HOUSE

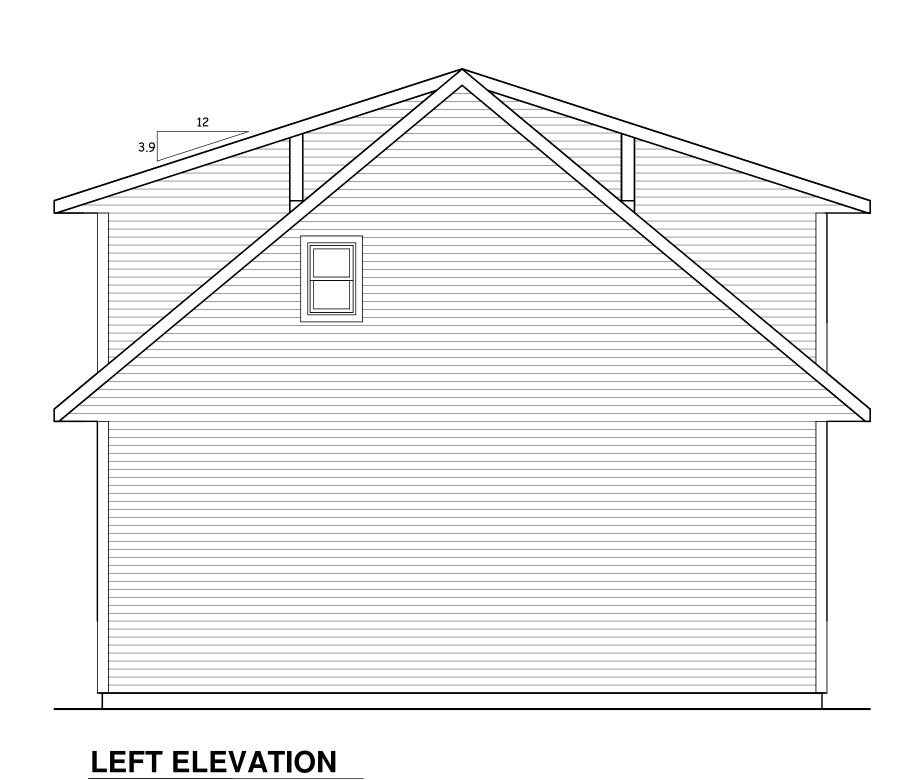





1/4" = 1'-0"




1/4" = 1'-0"


REAR ELEVATION

1/4" = 1'-0"

HUTH CARRIAGE HOUSE



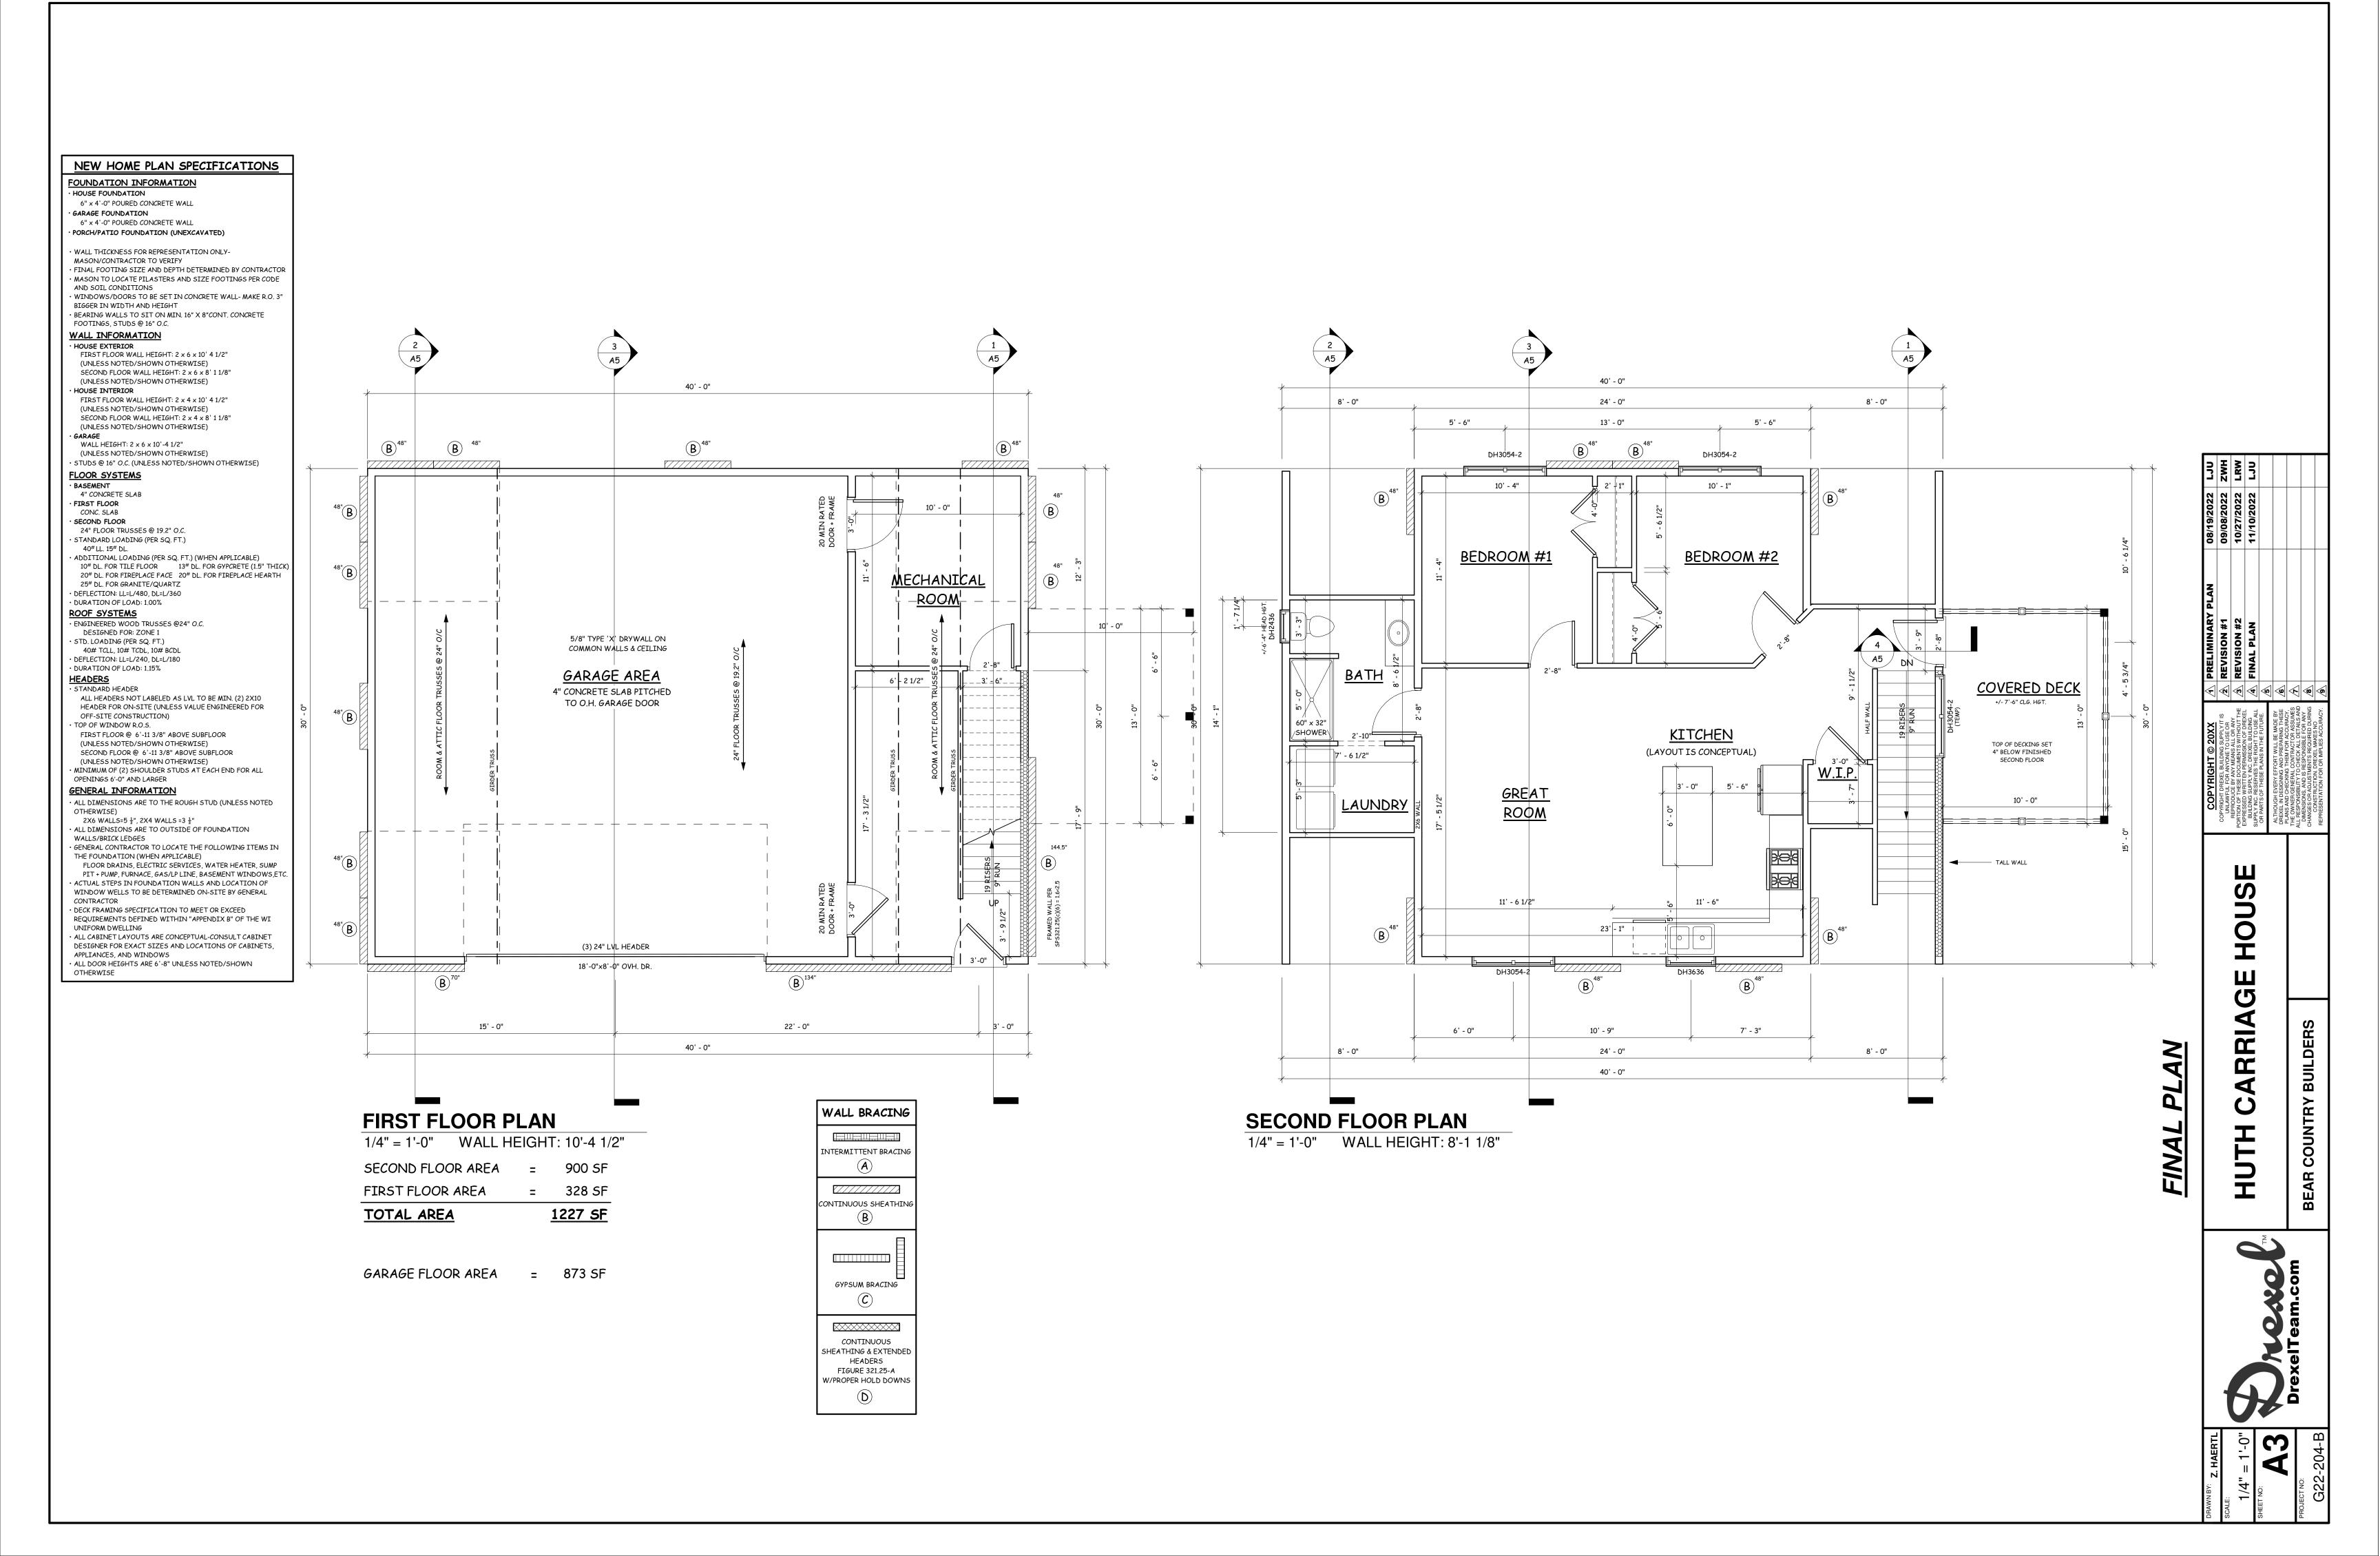

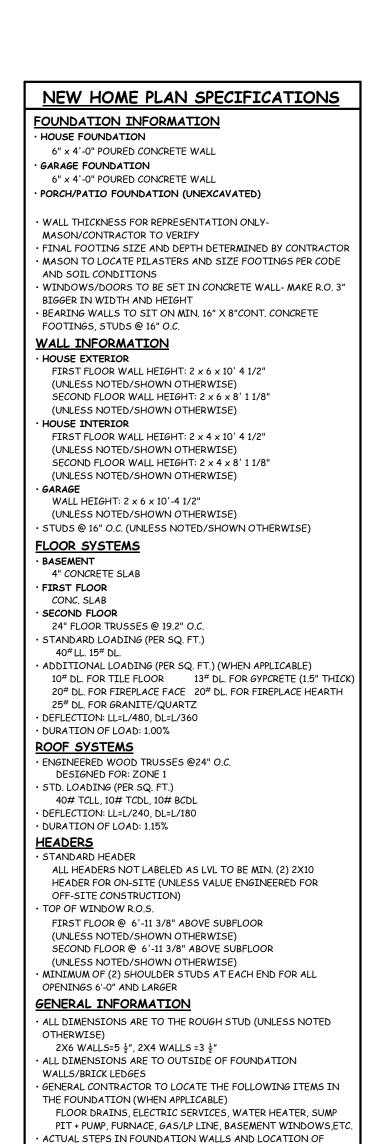

WINDOW WELLS TO BE DETERMINED ON-SITE BY GENERAL

· ALL CABINET LAYOUTS ARE CONCEPTUAL-CONSULT CABINET DESIGNER FOR EXACT SIZES AND LOCATIONS OF CABINETS,

· DECK FRAMING SPECIFICATION TO MEET OR EXCEED REQUIREMENTS DEFINED WITHIN "APPENDIX B" OF THE WI


· ALL DOOR HEIGHTS ARE 6'-8" UNLESS NOTED/SHOWN

CONTRACTOR

OTHERWISE

UNIFORM DWELLING

APPLIANCES, AND WINDOWS

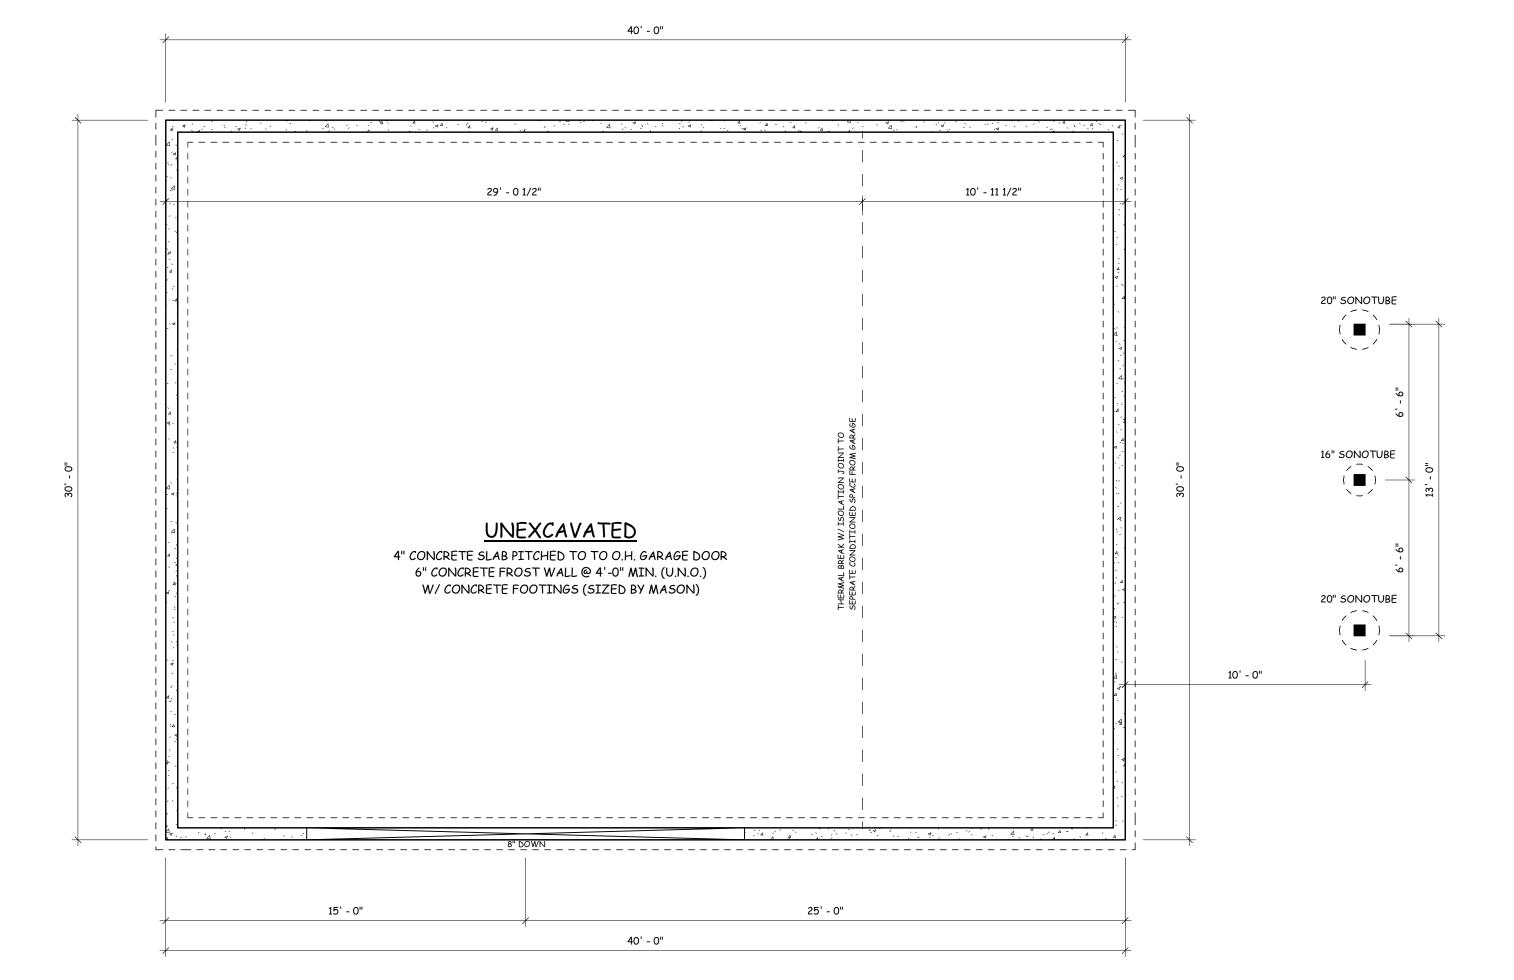


FOUNDATION PLAN 1/4" = 1'-0" WALL HEIGHT: 4'-0"

RRIA

HOU

BUILDE

		B
	2 meace	DrexelTeam.com
2		٥

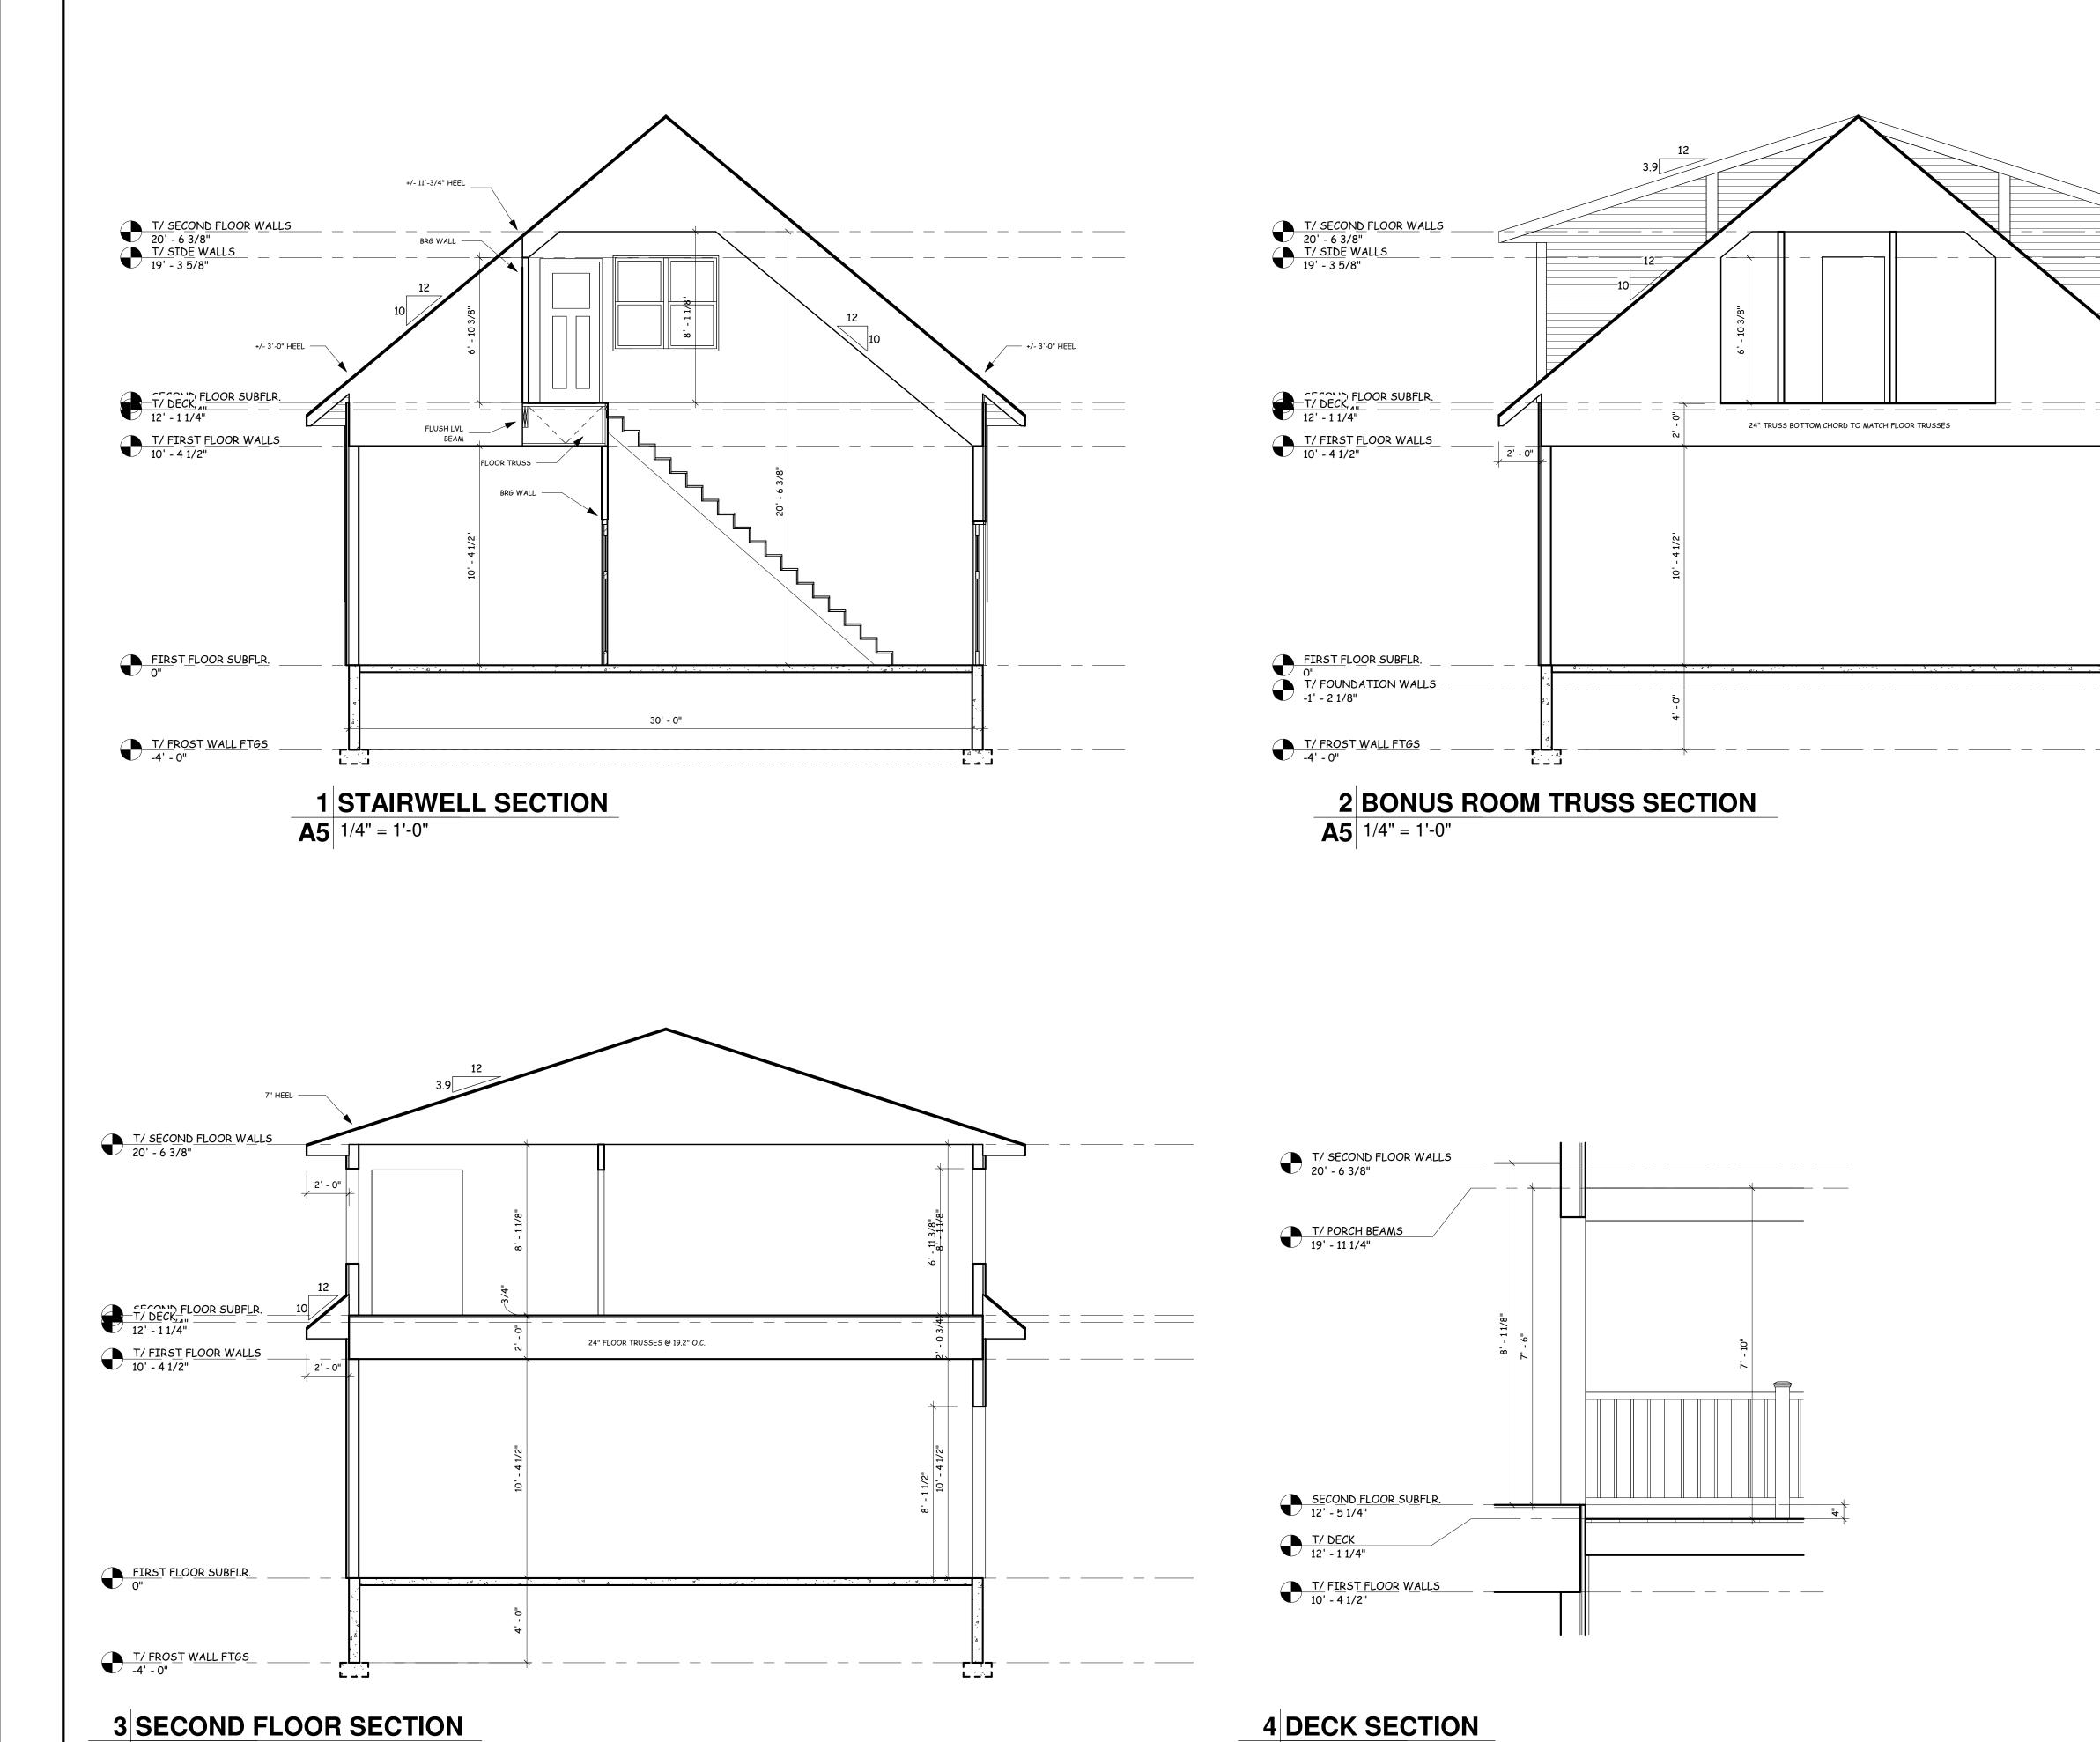

A5 1/2" = 1'-0"

A5 1/4" = 1'-0"

FINAL PLAN

HUTH CARRIAGE HOUSE

Show of the state of the state

Scale:

As indicated SHEET NO:

A5

PROJECT NO:

G22-204-B