### **GENERAL CONSTRUCTION NOTES**

DRAWINGS ARE NOT TO BE SCALED.

ALL DIMENSIONS AND INSTALLATIONS ARE TO BE VERIFIED ON SITE.

ALL DIMENSION MEASURED FROM THE FACE OF STUD.

ALL DIMENSIONS ARE TAKEN TO OUTSIDE FACE OF CONCRETE.

ALL DIMENSIONS ARE MEASURED TO CENTERLINE OF DOORS AND WINDOWS.

CENTERLINE OF GRID = CENTERLINE OF PARTY WALL.

THESE DRAWINGS ARE TO BE READ IN CONJUNCTION WITH CIVIL, STRUCTURAL, MECHANICAL, ELECTRICAL DRAWINGS, GEOTECHNICAL REPORT, AND ALL OTHER CONSULTANTS'S DRAWINGS.

ANY UN-REFERENCED ASSEMBLIES, DETAILS, WINDOWS OR DOORS IN ANY DRAWING ARE TO BE DISREGARDED FROM THE SCOPE OF WORK.

ALL CONSTRUCTION TO COMPLY TO THE LATEST EDITION OF THE ALBERTA BUILDING CODE (ABC), PLUS ANY AND ALL AUTHORITIES HAVING JURISDICTION DURING ALL PHASES OF WORK.

IT IS THE CONTRACTOR'S RESPONSIBILITY TO BRING ALL OMISSIONS, DISCREPANCIES, INCLUDING DIMENSIONS, TO THE ATTENTION OF THE CONSULTANT PRIOR TO COMMENCING OF ANY WORK.

ALL DOORS AND WINDOWS SHOWN ON PLANS ARE NOMINAL SIZES, REFER TO DOOR SCHEDULE AND WINDOW SCHEDULE FOR ACTUAL SIZES. CONFIRM ROUGH OPENING SIZE AND INSTALLATION REQUIREMENTS WITH MANUFACTURER. VERIFY EACH AND INDIVIDUAL ROUGH OPENING PROPER TO FABRICATION. EXTERIOR DOORS & WINDOWS TO BE INSTALLED AS PER THE MANUFACTURERS' RECOMMENDATIONS & SPECIFICATION.

PROVIDE SOLID BLOCKING AS REQUIRED FOR FIXTURES ATTACHMENT (ARCHITECTURAL ITEMS - WASHROOM ACCESSORIES, HANDRAILS, ETC. MECHANICAL ITEMS - FANS, THERMOSTAT, SPRINKLER HEADS, ETC. ELECTRICAL ITEMS - ALARMS, FIXTURES, ETC.)

CONTRACTOR TO COORDINATE OF DUCTING, VENTILATION, MECHANICAL CHASES AND WASHER AND DRYER WITH MECHANICAL SUB-CONTRACTOR.

DIVISION B, 9.10.9 ELECTRICAL AND SERVICE EQUIPMENT PENETRATING A FIRE SEPARATION SHALL BE TIGHTLY FITTED OR FIRE STOPPED TO MAINTAIN THE INTEGRITY OF THE SEPARATION.

DIVISION B, 9.27.3.8. ENSURE FLASHING IS INSTALLED AT EVERY HORIZONTAL JUNCTION, HORIZONTAL OFFSET, AND HORIZONTAL CHANGE BETWEEN CLADDING ELEMENTS.

ALL CONSTRUCTION TO COMPLY TO INDUSTRY / TRADE STANDARDS ALONG WITH MANUFACTURE RECOMMENDATION AND SPECIFICATIONS, PROVIDE SHOP DRAWINGS, SAMPLES AND OPERATING MANUALS.

ANY PATCHING, REPAIR, REFINISHING, RECONSTRUCTION & REPAINTING WORK REQUIRED AS A RESULT OF PERFORMANCE OF WORK OF THIS CONTRACT SHALL INCORPORATE & BE PERFORMED WITH MATERIALS TO MATCH SAME & SHALL MAINTAIN REQUIRED FIRE RATINGS

IT IS THE CONTRACTORS RESPONSIBILITY TO ENSURE THAT WHEREVER A FIRE SEPARATION IS REQUIRED AS INDICATED BY THE CONSTRUCTION TYPE ON THE DRAWINGS, ALL COMPONENTS OF THE ASSEMBLY ARE TO BE APPROVED MATERIALS WITH INSTALLATION / FABRICATION PROCEDURES PER DIRECTIONS OF THE ULC NUMBER & OR REQUIREMENTS OF THE ABC 2014, ALL FIRE SEPARATIONS MUST BE CONTINUOUS WITHIN THEIR EXTENT & ALL JOINTS TO BE AIRTIGHT

PROVIDE & MAINTAIN CONTINUOUS AIR / VAPOR BARRIER SYSTEMS, CAULK AROUND OPENINGS & GAPS WITH SEALANT TO ACHIEVE CONTINUOUS BARRIER, ALL NAIL HOLES IN EXTERIOR WOODWORK TO BE FILED WITH APPROVED FILLER PRIOR TO FINISHING, SEAL ALL EXTERIOR JOINTS WITH APPROVED SEALANT

PROVIDE & MAINTAIN CONTINUOUS ACOUSTIC BARRIERS, AVOID SOUND TRANSMISSION THROUGH DIRECT CONTACTS @ ACOUSTICALLY TREATED SURFACES

THE AREAS REQUIRING VENTILATION WITHIN ROOF SPACE OR ATTIC SHALL CONFORM TO ABC-9.19.1.2

COORDINATE SIZE, LOCATION OF DUCTING, VENTILATION, MECHANICAL CHASES & WASHER / DRYER W/ OWNER, REFER ALSO TO MECHANICAL PLANS & SPECIFICATIONS

ALL WALL ASSEMBLIES THAT REQUIRE CEMENTITIOUS OR WOOD SIDING/PANEL FINISH SHALL BE RAINSCREENED AND INSTALLED AS PER MANUFACTURERS INSTRUCTIONS, 3/8" X 3 1/2" WOOD STRAPPING SHALL BE INSTALLED BETWEEN THE SIDING AND WALL ASSEMBLY

F.J

HWT

### **GENERAL ABBREVIATIONS**

CANT.	= CANTILEVER
COS	= CONFIRM ON SITE
NIC	

- NIC = NOT IN CONTRACT 0.C. = ON CENTRE
- = UNDER SIDE U/S
- = COMPLETE WITH c/w AFF = ABOVE FINISHED FLOOR
- CJ = CONTROL JOINT СТ = CERAMIC TILE
- RWL = RAIN WATER LEADER = ELECTRICAL PANEL FP = SANITARY LINE SAN HB = HOSE BIB ALUM = ALUMINUM CONC = CONCRETE P.T. = PRE-TREATED

= EXPANSION JOINT

= HOT WATER TANK

BUILDING CODE ANALYSIS.				
APPLICABLE CODE: APPLICABLE CODE SECTION: BUILDING CLASSIFICATION (9.10.2.1)		A.B.C 2014 PART 9 GROUP C - RESIDENTIAL		
BUILDING HEIGHT: TYPE OF CONSTRUCTION: TYPE OF CLADDING: BUILDING SPRINKLERED:		3 STORIES MAXIMUM COMBUSTIBLE COMBUSTIBLE SPRINKLERED		
9.8.2.1	STAIRS 2) MINIMUM WIDTH = 860MM			
9.8.2.1	ĆLEAR HEIGHT	444		
9.8.4.1	<ol> <li>MINIMUM CLEAR HEIGHT = 1950N RISER DIMENSION: MIN = 125MM; M</li> </ol>			
9.8.4.2	TREAD DIMENSION: RUN MIN = 125000, 10 TREAD DIMENSION: RUN MIN = 210			
9.8.7.1	HANDRAILS; ONLY ONE SIDE REQU			
9.8.7.2	HANDRAIL SHALL BE CONTINUOUS			
9.8.7.4	HEIGHT OF HANDRAILS SHALL BE			
9.9.10.1	1) WINDOW REQUIRED IN EACH BE			
5.5.10.1	2) WINDOW KLEGIKED IN EACH DE DIMENSION LESS THAN 380MM			
9.10.8.1	45 MIN FRR BETWEEN DWELLING L	INITS MINIMUM FOR FLOORS		
9.10.9.2	FIRE RATED WALL/FLOOR ASSEMB			
9.10.11.2	FIRE SEPARATION BETWEEN TWO			
5.10.11.2		OF 1 HOUR FRR TO THE U/S OF ROOF DECK.		
9.10.12.4	1) SOFFITS SHALL BE PROTECTED			
0.10.12.4	DOOR/WINDOW OR <1.2M ON EITH			
	DOOR.			
9.10.14.5	BASED ON UNPROTECTED OPENIN	G % REOS, COMBUSTIBLE		
0.10.11.0	CONSTRUCTION AND CLADDING AL			
	WALLS			
9.10.19.3	SMOKE ALARMS SHALL BE INSTAL	ED IN EACH SI EEPING		
0.10.10.0	ROOM AND HALLWAY (OR LOCATIO			
	ROOMS) ON OR NEAR CEILING			
9.10.19.4	SMOKE ALARMS SHALL BE CONNER	CTED TO A PERMANENT		
	SOURCE OF POWER.			
9.11.2.1	MINIMUM REQUIRED STC RATING	S 50 BETWEEN UNITS		
9.13.4.2	1) ALL ASSEMBLIES SEPARATING T			
0.10.1.2		PROTECTED BY AN AIR BARRIER SYSTEM		
(9.52.3)				
()	2) DWELLING UNITS AND BUILDING	S SHALL BE PROVIDED WITH A ROUGH IN FOR A		
	RADON EXTRACTION SYSTEM CON			
9.13.4.3 1)	FLOORS SHALL BE PROVIDED WITH			
••••••••	FLOOR DEPRESSURIZATION CONS			
	a) GAS PERMEABLE LAYER, INLET			
		D A PIPE AS DESCRIBED IN SENTENCE (3)		

b) CLEAN GRANULAR MATERIAL AND A PIPE AS DESCRIBED IN SENTENCE (3) 2) ROUGH IN SHALL INCLUDE

a) GAS PERMEABLE LAYER BETWEEN AIR BARRIER AND GROUND; b) INLET TO ALLOW DEPRESSURIZATION c) AN OUTLET IN THE CONDITIONED SPACE THAT:

i) PERMITS CONNECTION TO DEPRES. EQUIPMENT;

ii) SEALED, AND;

iii) LABELED TO INDICATE ITS USE TO REMOVE RADON 3) ROUGH IN SHALL INCLUDE

a) CLEAN GRANULAR MATERIAL INSTALLED BELOW FLOOR (NOT LESS THAN 100MM IF COARSE CLEAN GRANULAR MATERIAL CONTAINING MORE THAN 10% OF MATERIAL THAT WILL PASS A 4MM SIEVE) b) PIPE NOT LESS THAN 100MM IN DIAMETER WILL BE INSTALLED THROUGH

THE FLOOR SUCH THAT: i) BOTTOM END OPENS INTO GRANULAR LAYER REQUIRED CLAUSE (a) AT OR NEAR THE CENTER OF FLOOR AND NOT LESS THAN

100MM OF GRANULAR MATERIAL PROJECTS BEYOND THE TERMINUS OF PIPE MEASURED ALONG ITS AXIS

ii) TOP END PERMITS CONNECTION TO DEPRESS.

EQUIPMENT AND IS PROVIDED WITH AN AIRTIGHT CAP iii) PIPE IS LABELED TO SHOW THAT IT IS INTENDED TO REMOVE RADON FROM GROUND


### D<u>rawing index</u>

A1.0:	SITE PLAN
A2.0:	FOUNDATION PLAN
A2.1:	GROUND FLOOR PLAN

- A2.2: SECOND FLOOR FLOOR PLAN
- A2.3: LOFT FLOOR PLAN
- A2.4: ROOF PLAN
- A3.0: NORTH ELEVATION
- A3.1: SOUTH ELEVATION
- A3.2: EAST ELEVATION
- A3.3: WEST ELEVATION
- A3.4: WINDOW AND EXTERIOR DOOR DIAGRAM
- A4.0: SECTION 1
- A4.1: SECTION 2
- A4.2: CONSTRUCTION DETAILS

# 721 3rd Street, Canmore, Alberta



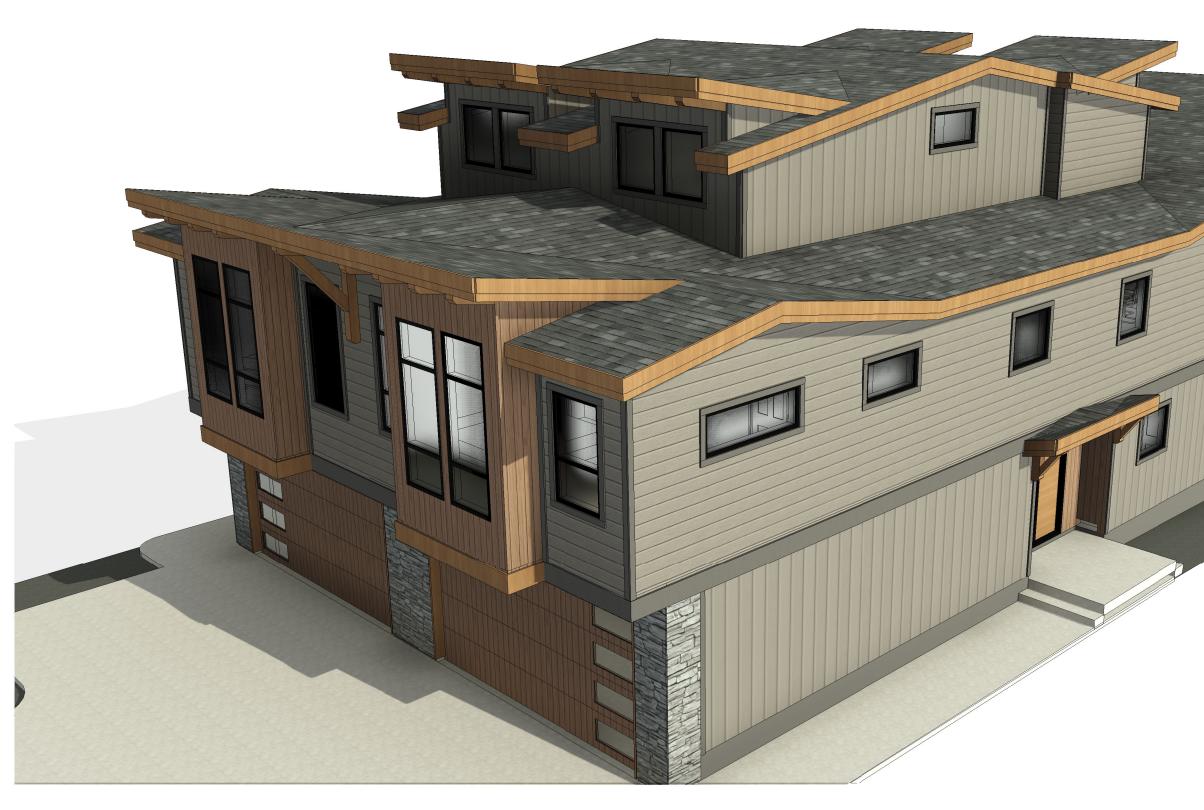



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CLIENT NAME lan Sarna and **Richard Greaves** 

PROJECT NAME

### 721 Duplex

721 3rd Street Canmore, Alberta

DRAWING TITLE

Cover

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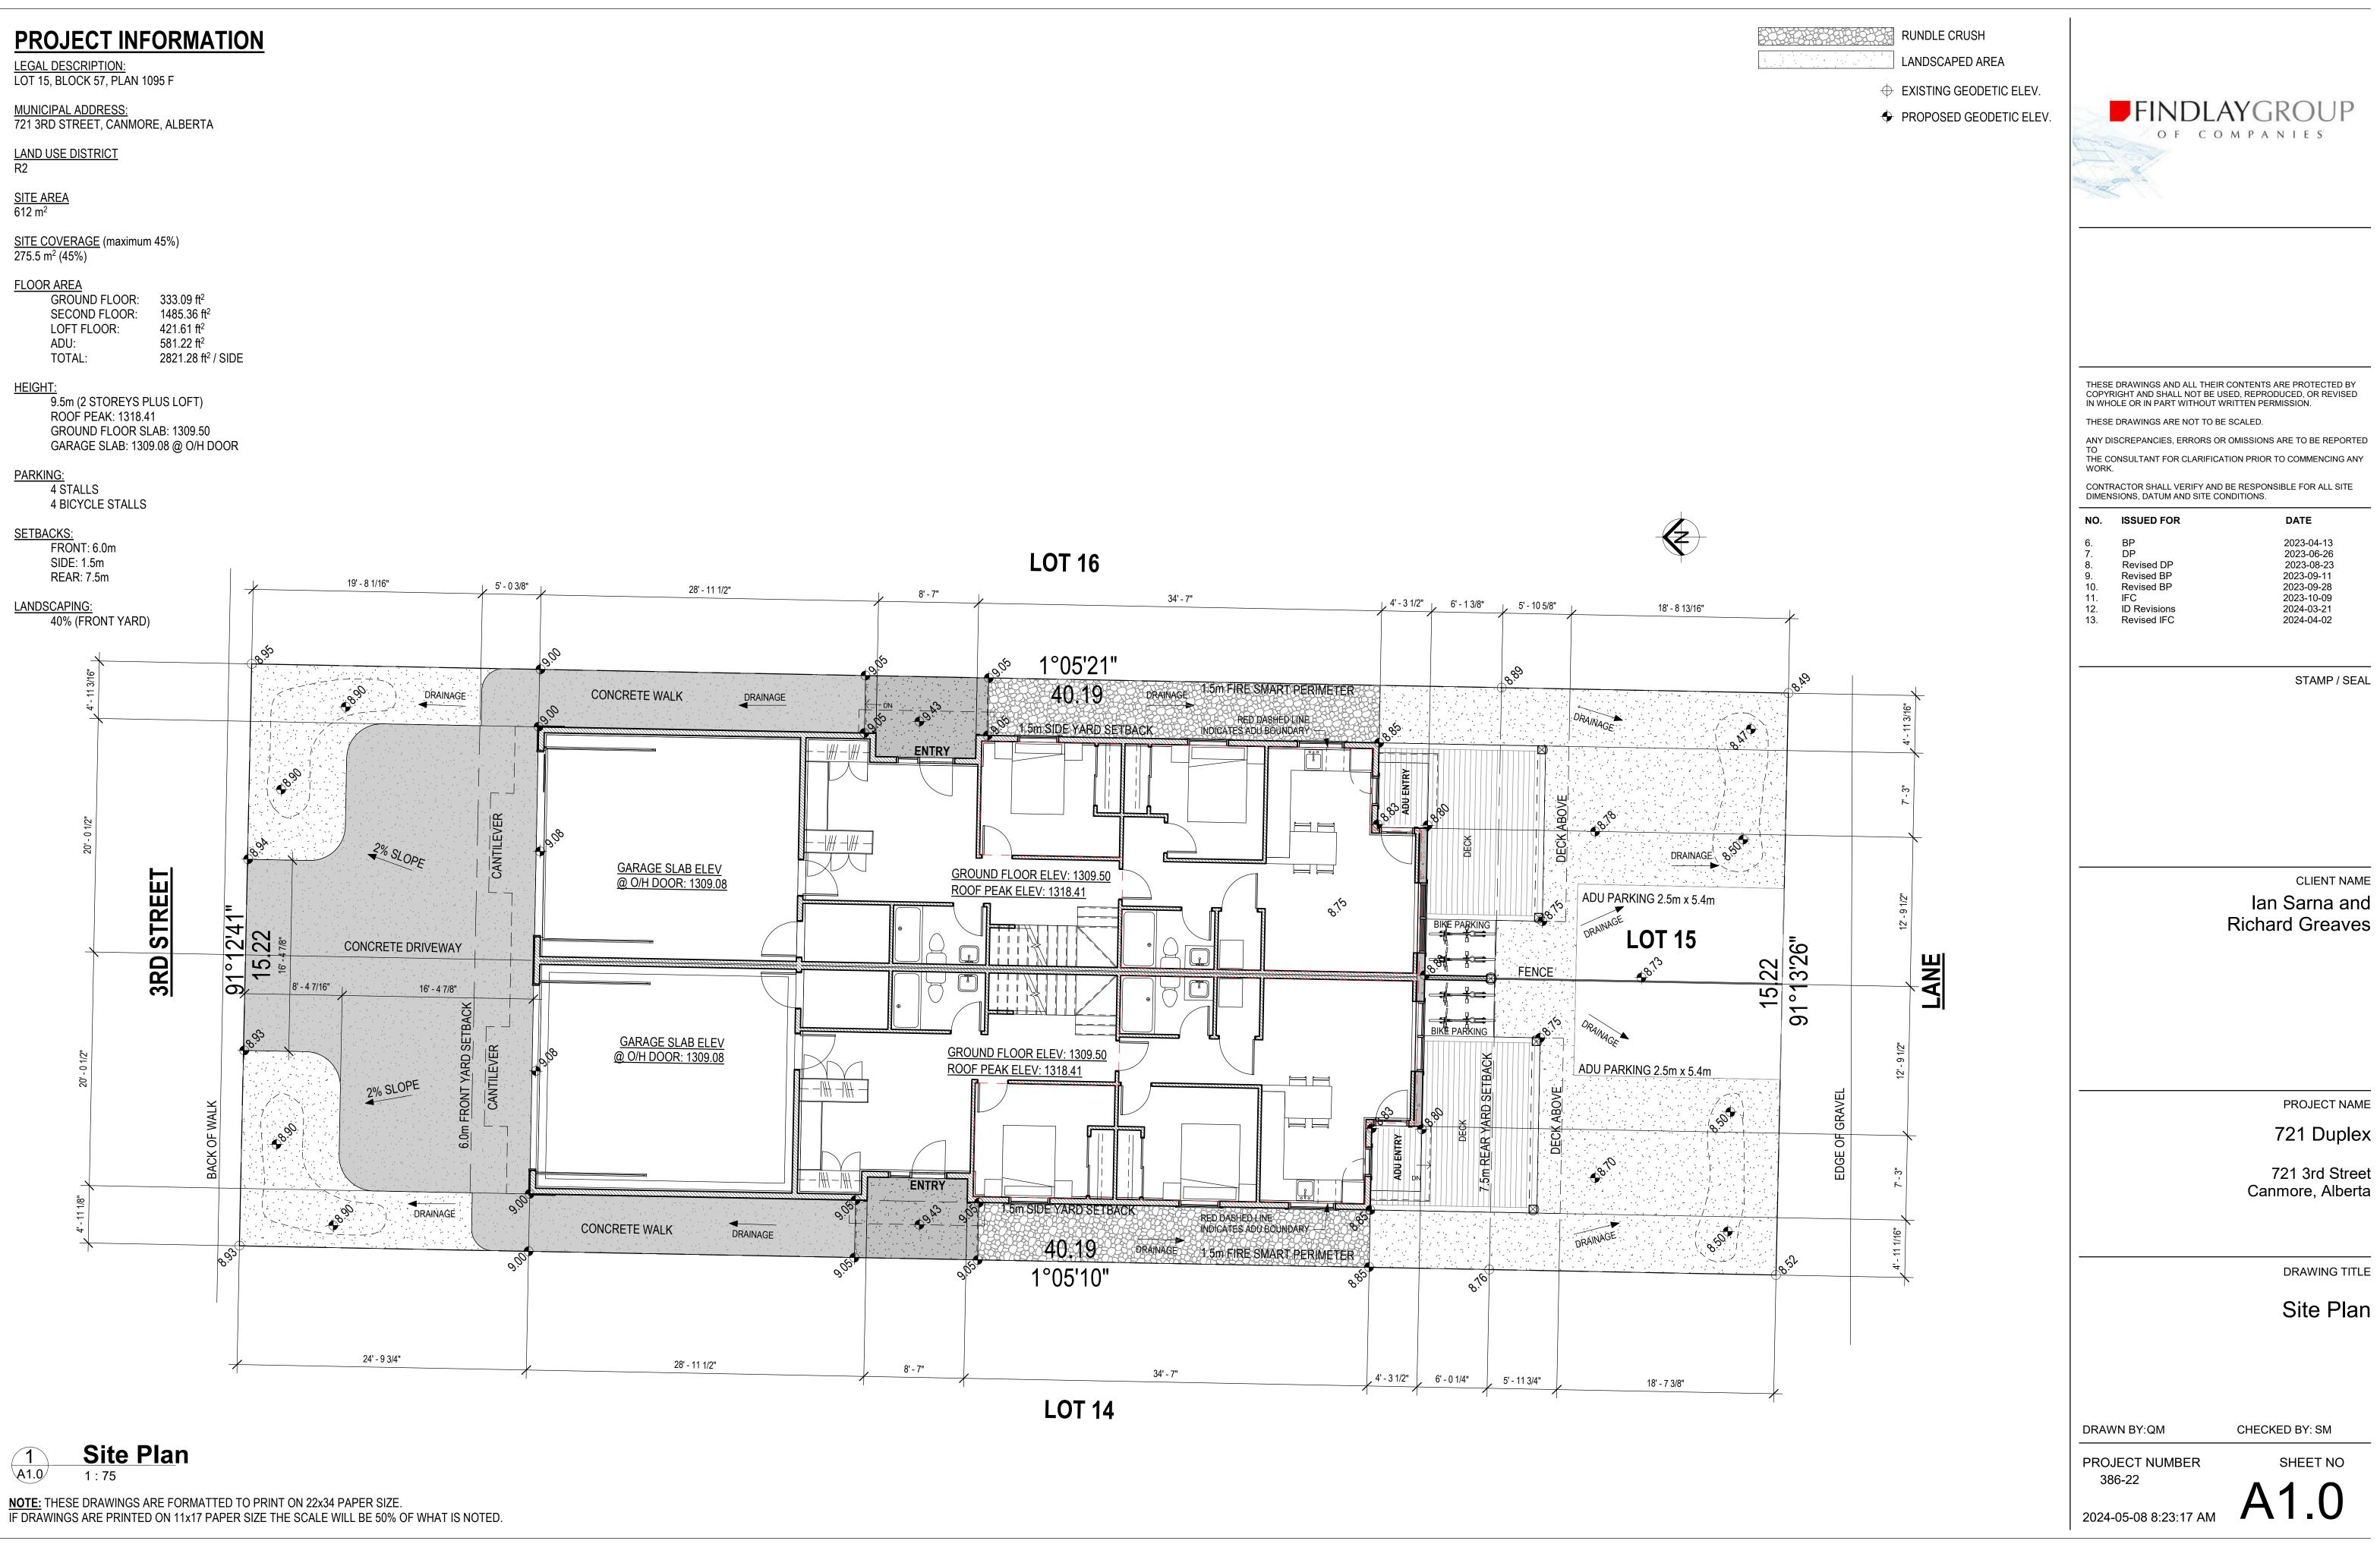
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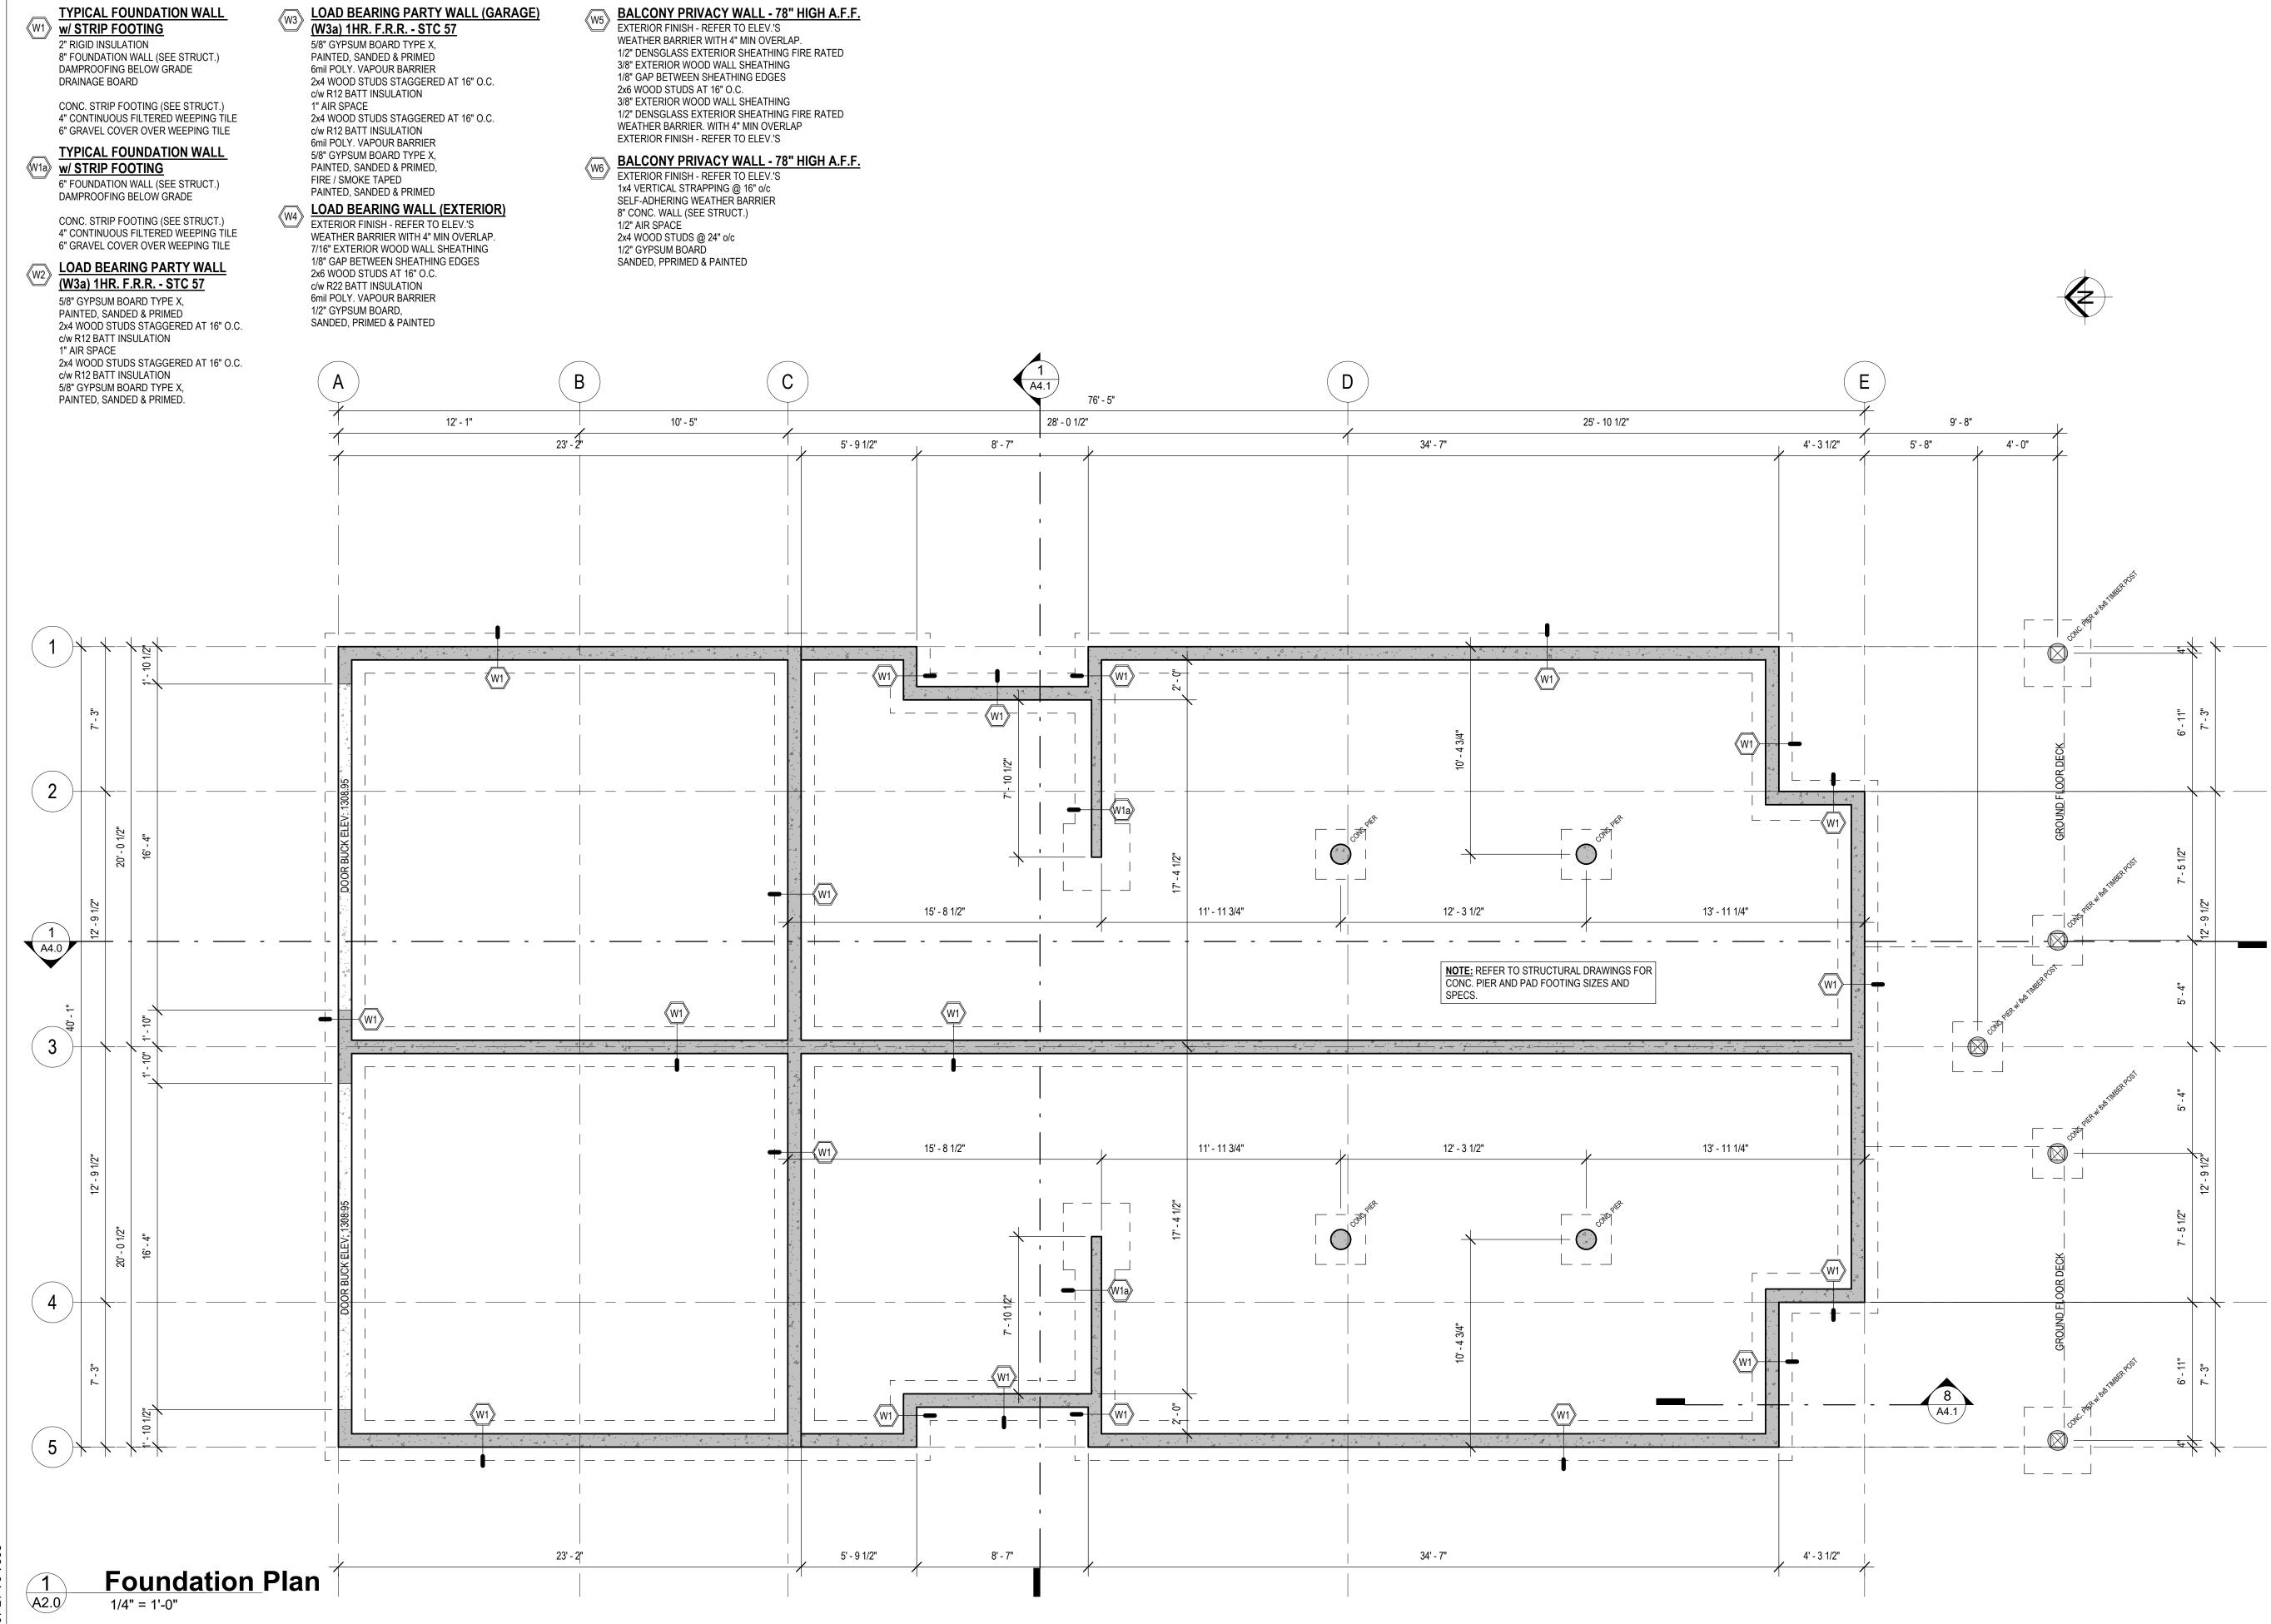
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PROJECT NAME

### 721 Duplex

721 3rd Street Canmore, Alberta

DRAWING TITLI

# Foundation Plan


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SYMBOL	SIZE	QUANTITY	DESCRIPTION	WALL SIZE
D1	2' - 6" x 6' - 8"	28	WOOD PANEL INTERIOR DOOR	2 X 4
(D2)	3' - 0" x 6' - 8"	4	WOOD PANEL INTERIOR DOOR	2 X 4
D3	2' - 6" x 6' - 8"	2	LOCKING 45 MINUTE FIRE RATED INTERIOR DOOR	2 X 4
D4)	3' - 0" x 6' - 8"	4	GARAGE SEPARATION DOOR w/ SELF CLOSER AND SMOKE SEAL	2 X 6
D5	2' - 6" x 6' - 8"	2	WOOD PANEL POCKET DOOR	2 X 4
D6	5' - 0" x 6' - 8"	4	DOUBLE SLIDING CLOSET DOOR-WOOD PANEL	2 X 4
(D7)	6' - 0" x 6' - 8"	2	DOUBLE SLIDING CLOSET DOOR-WOOD PANEL	2 X 4
	1	1		

# FDUIF



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8.	Revised DP	2023-08-23			
9.	Revised BP	2023-09-11			
10.	Revised BP	2023-09-28			
11.	IFC	2023-10-09			
12.	ID Revisions	2024-03-21			
13.	Revised IFC	2024-04-02			

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# Ground Floor Plan

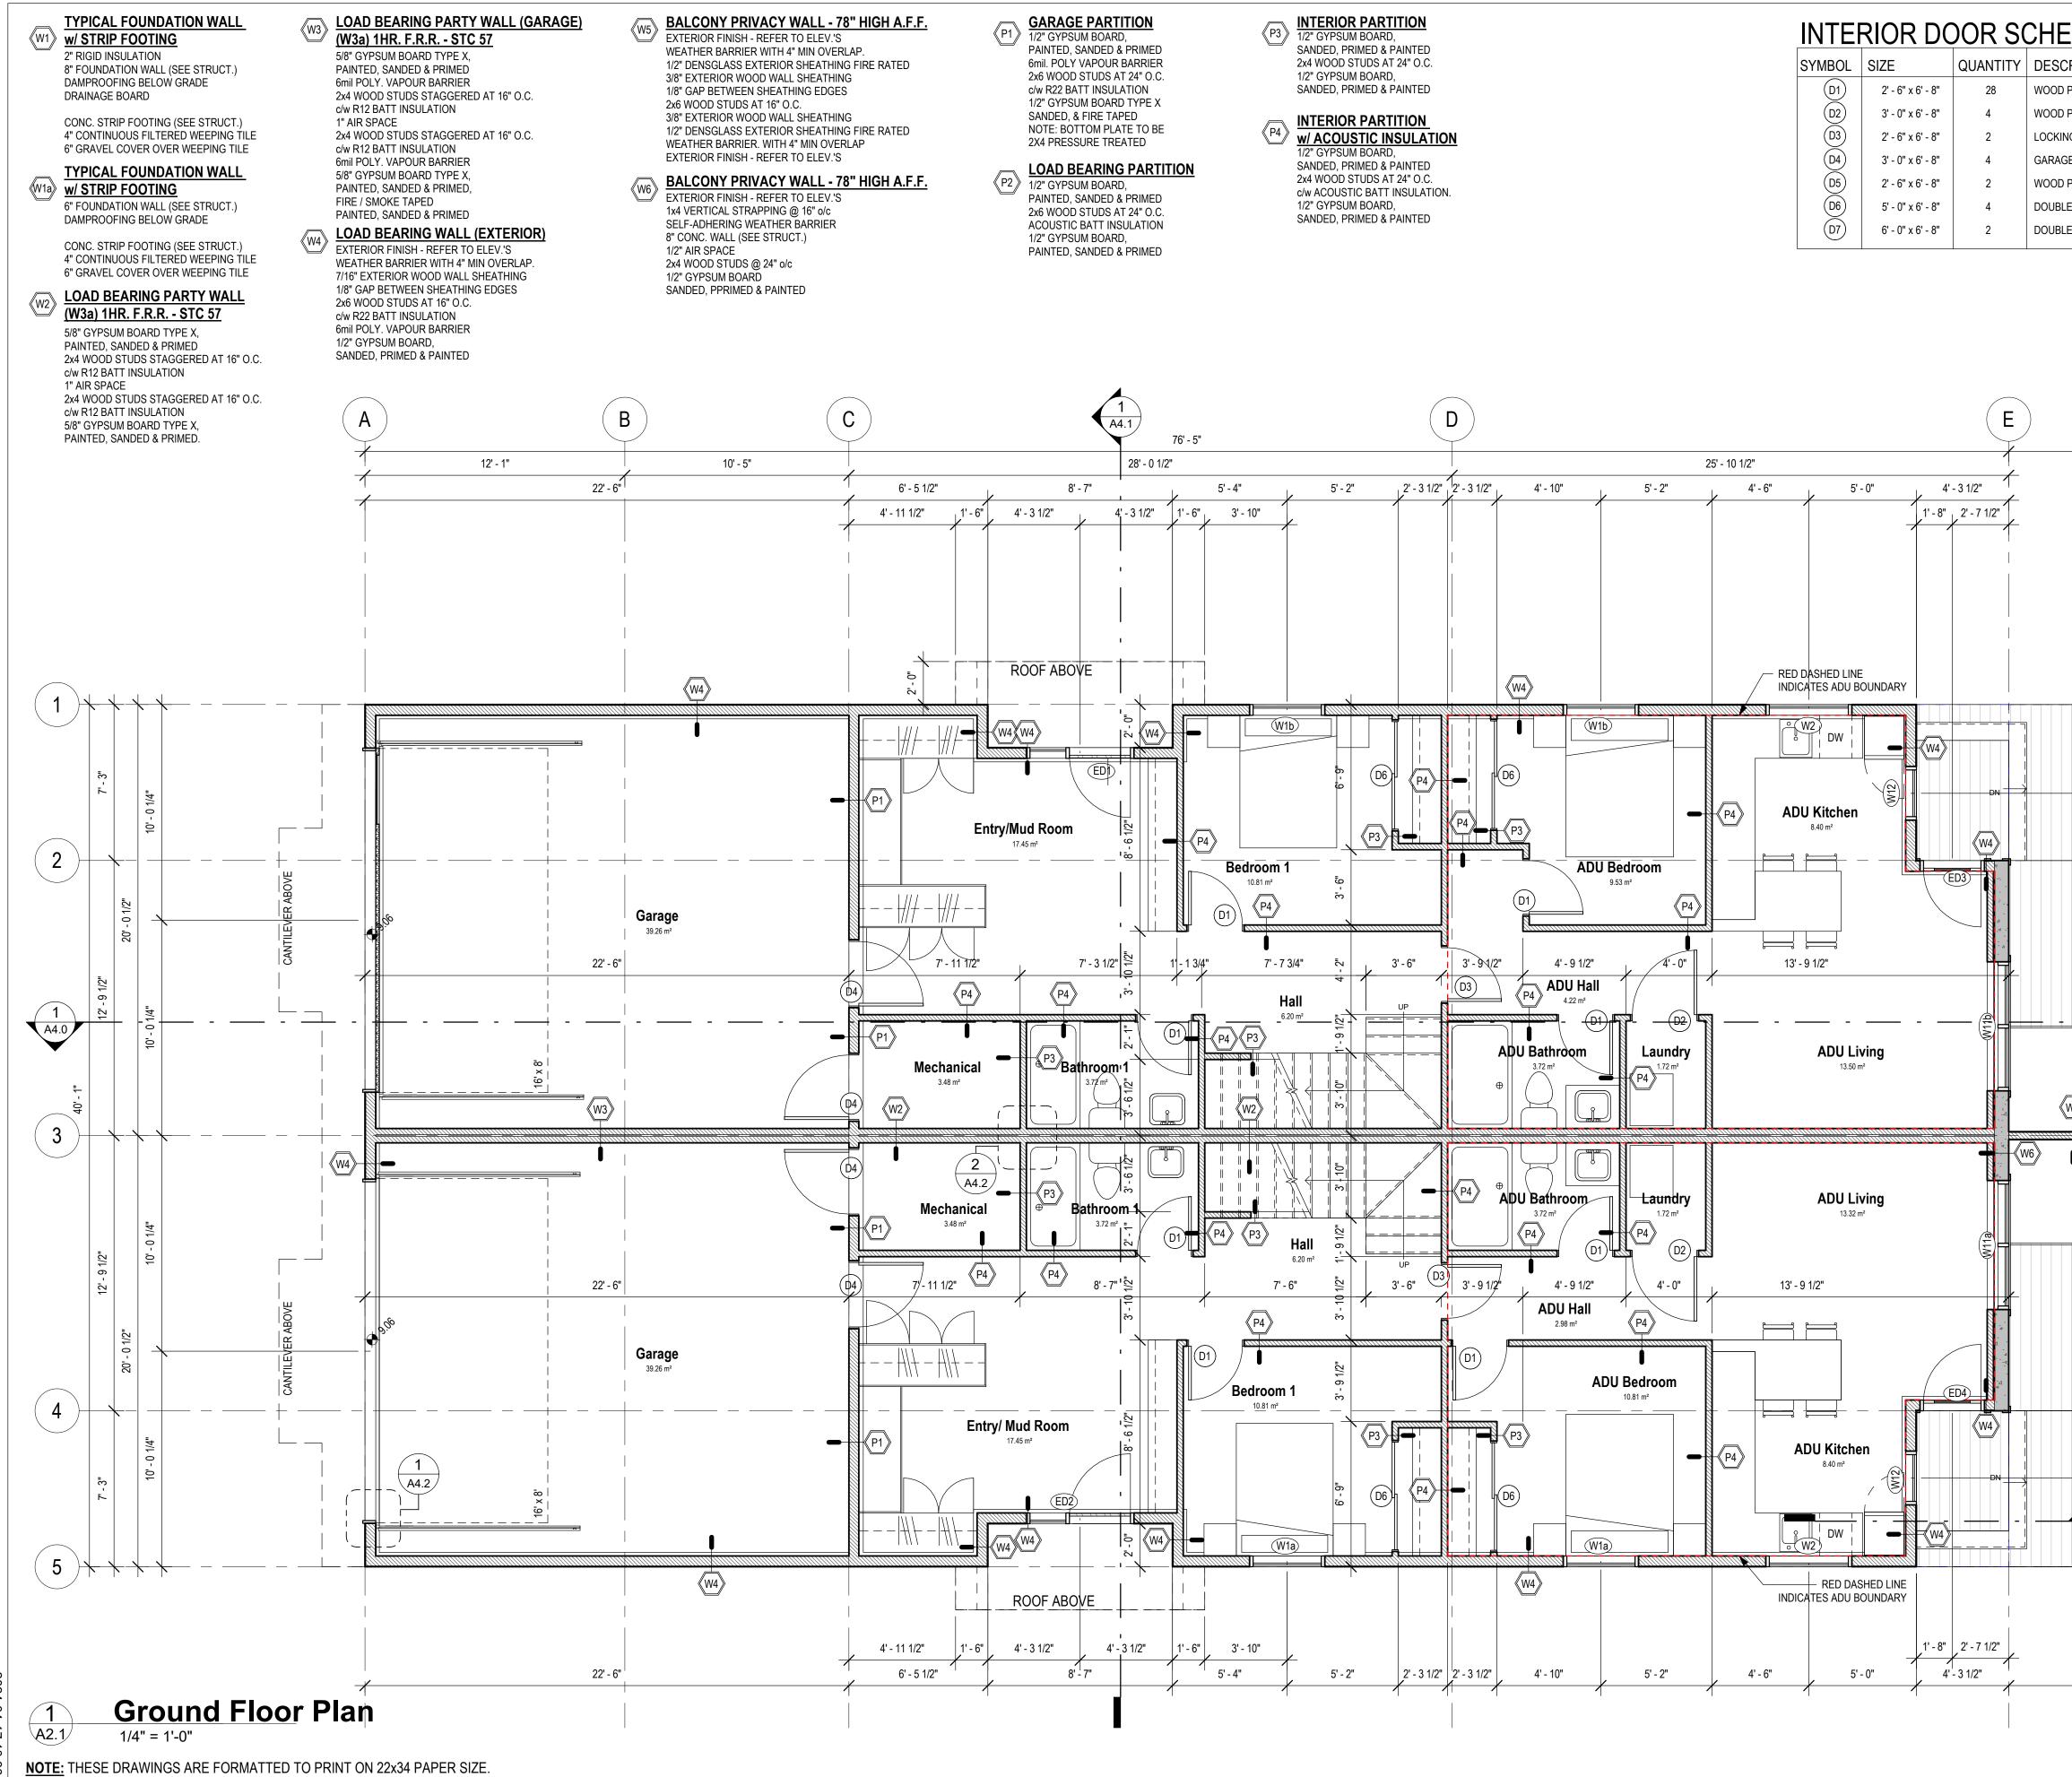
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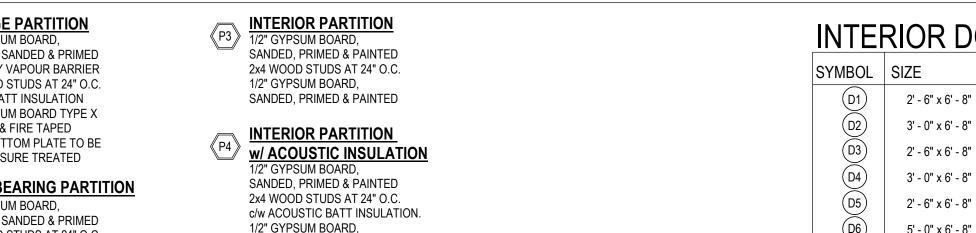
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SYMBOL	SIZE	QUANTITY	DESCRIPTION	WALL S
D1)	2' - 6" x 6' - 8"	28	WOOD PANEL INTERIOR DOOR	2 X 4
D2	3' - 0" x 6' - 8"	4	WOOD PANEL INTERIOR DOOR	2 X 4
D3	2' - 6" x 6' - 8"	2	LOCKING 45 MINUTE FIRE RATED INTERIOR DOOR	2 X 4
D4)	3' - 0" x 6' - 8"	4	GARAGE SEPARATION DOOR w/ SELF CLOSER AND SMOKE SEAL	2 X 6
(D5)	2' - 6" x 6' - 8"	2	WOOD PANEL POCKET DOOR	2 X 4
(D6)	5' - 0" x 6' - 8"	4	DOUBLE SLIDING CLOSET DOOR-WOOD PANEL	2 X 4
(D7)	6' - 0" x 6' - 8"	2	DOUBLE SLIDING CLOSET DOOR-WOOD PANEL	2 X 4

12' - 0"



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# Second Floor Plan

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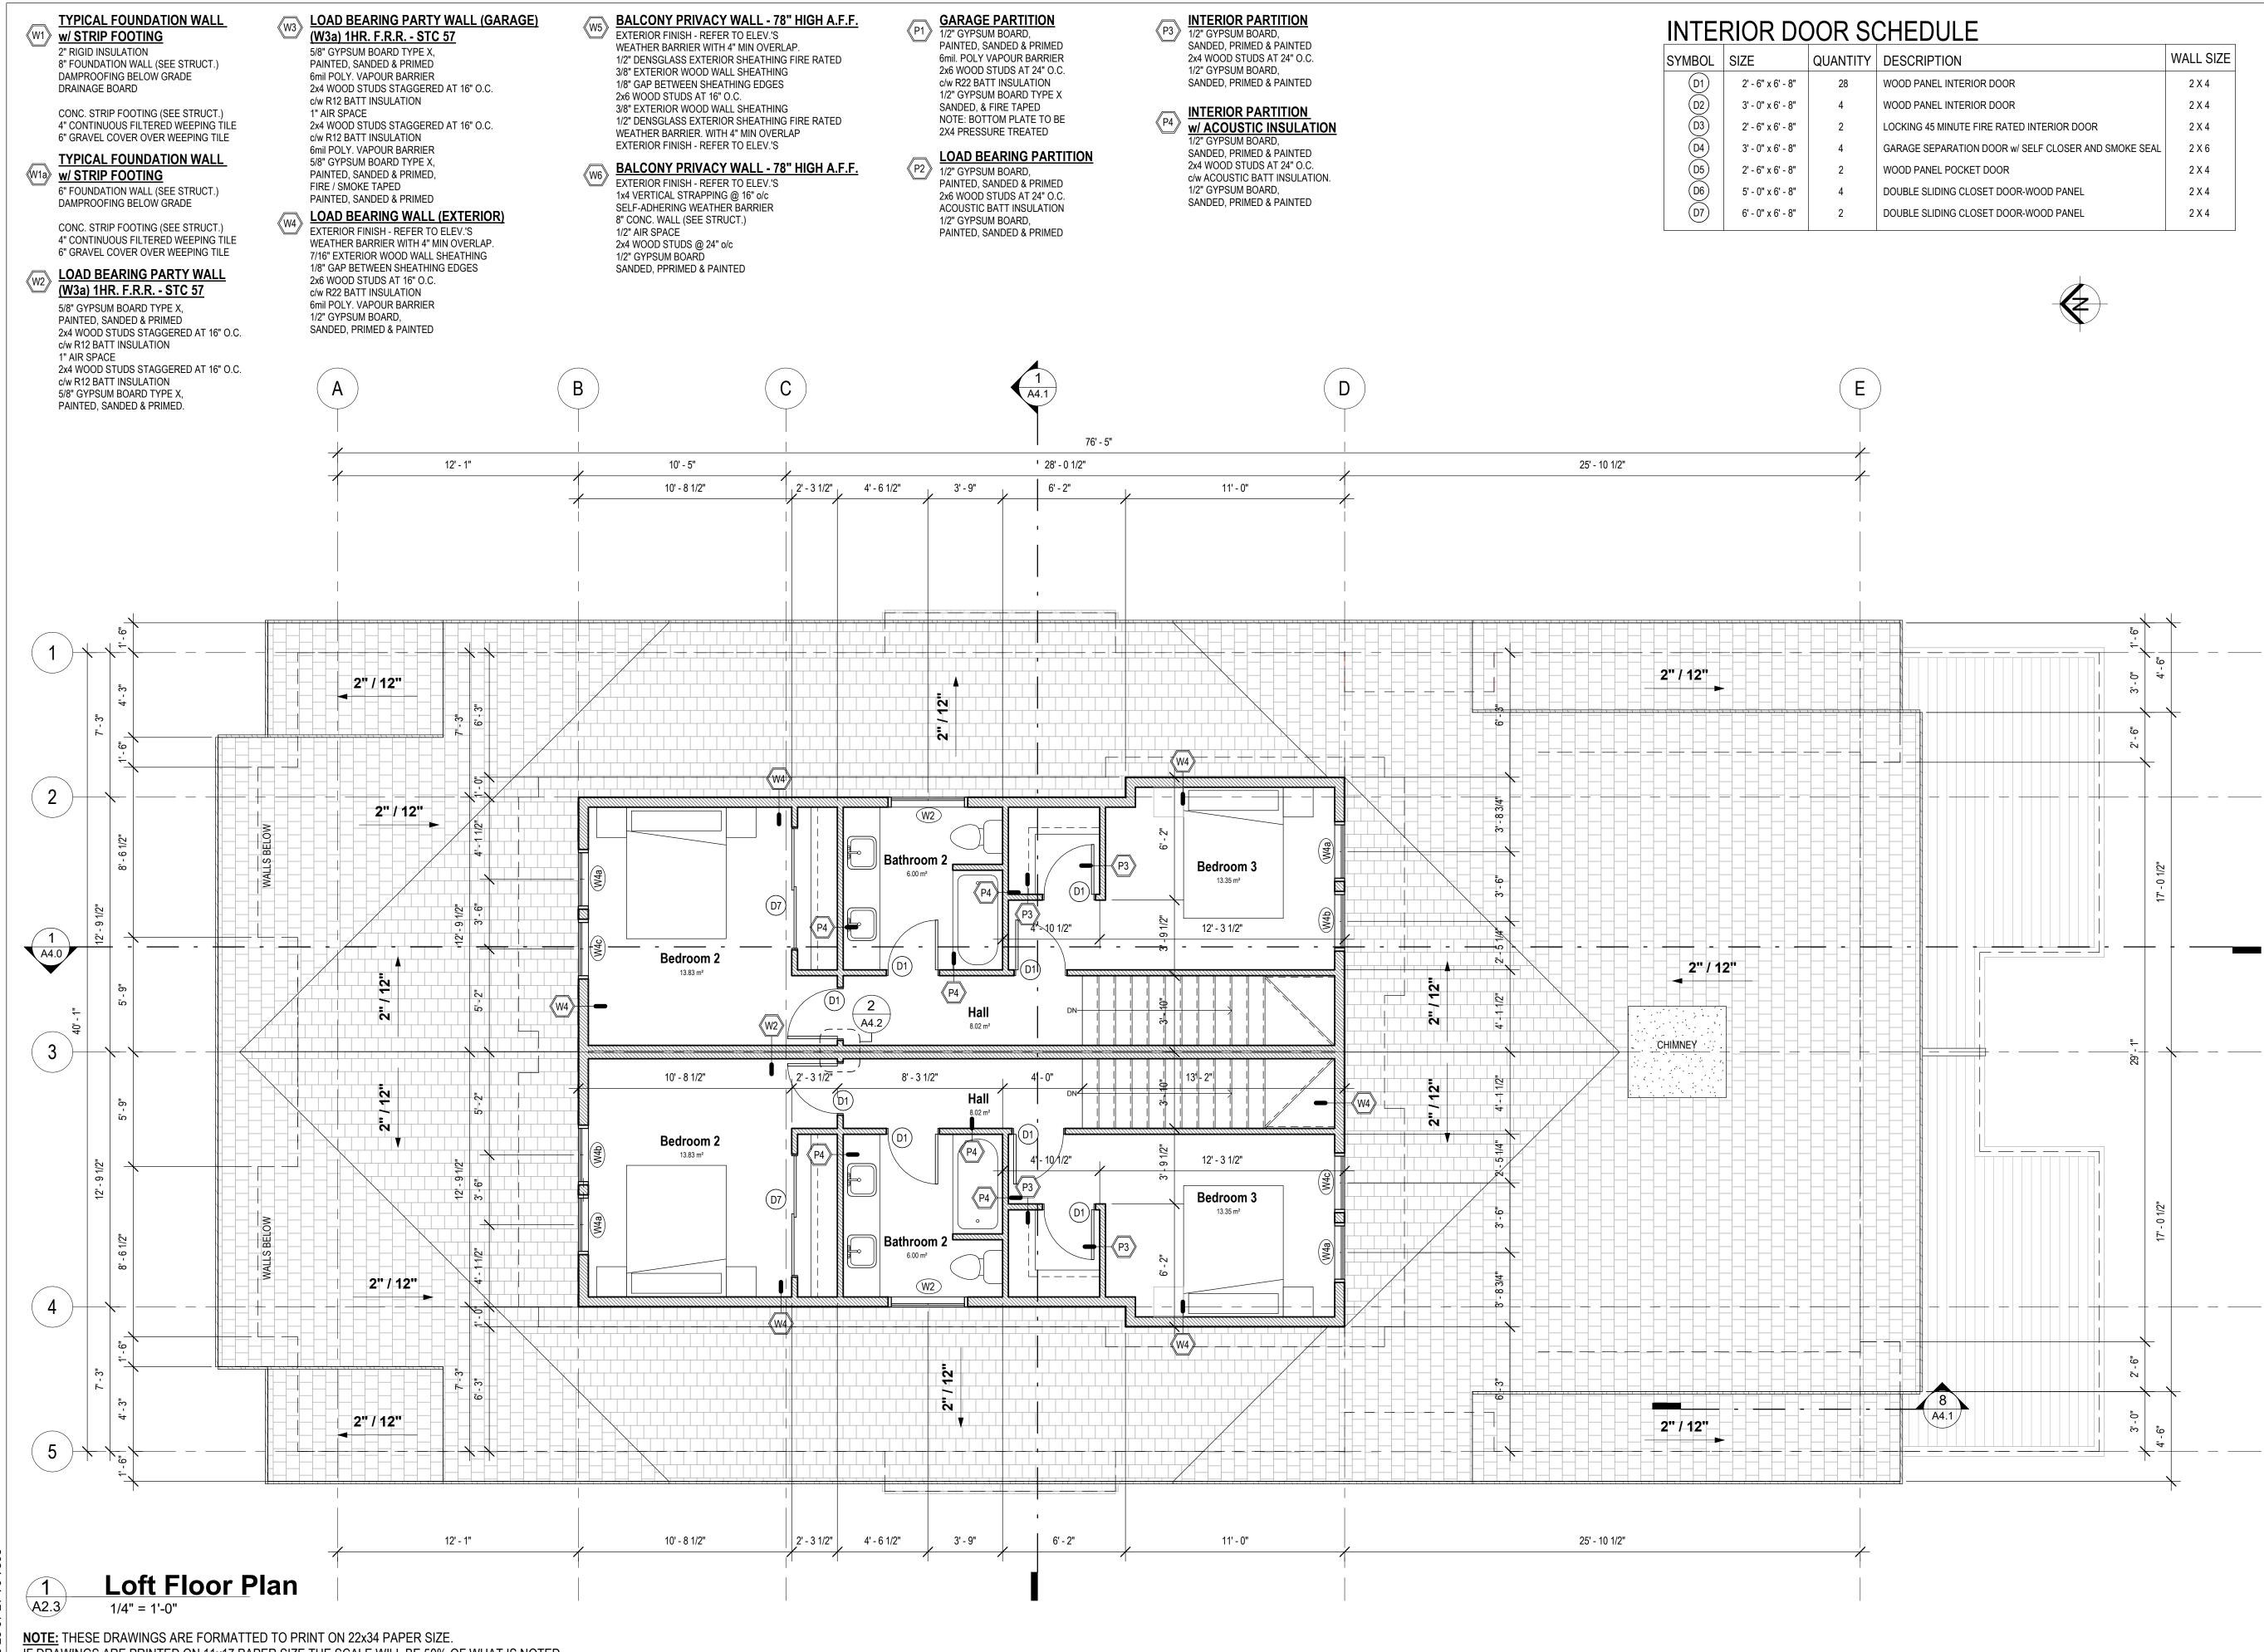
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6' | 0" 8 A4.1

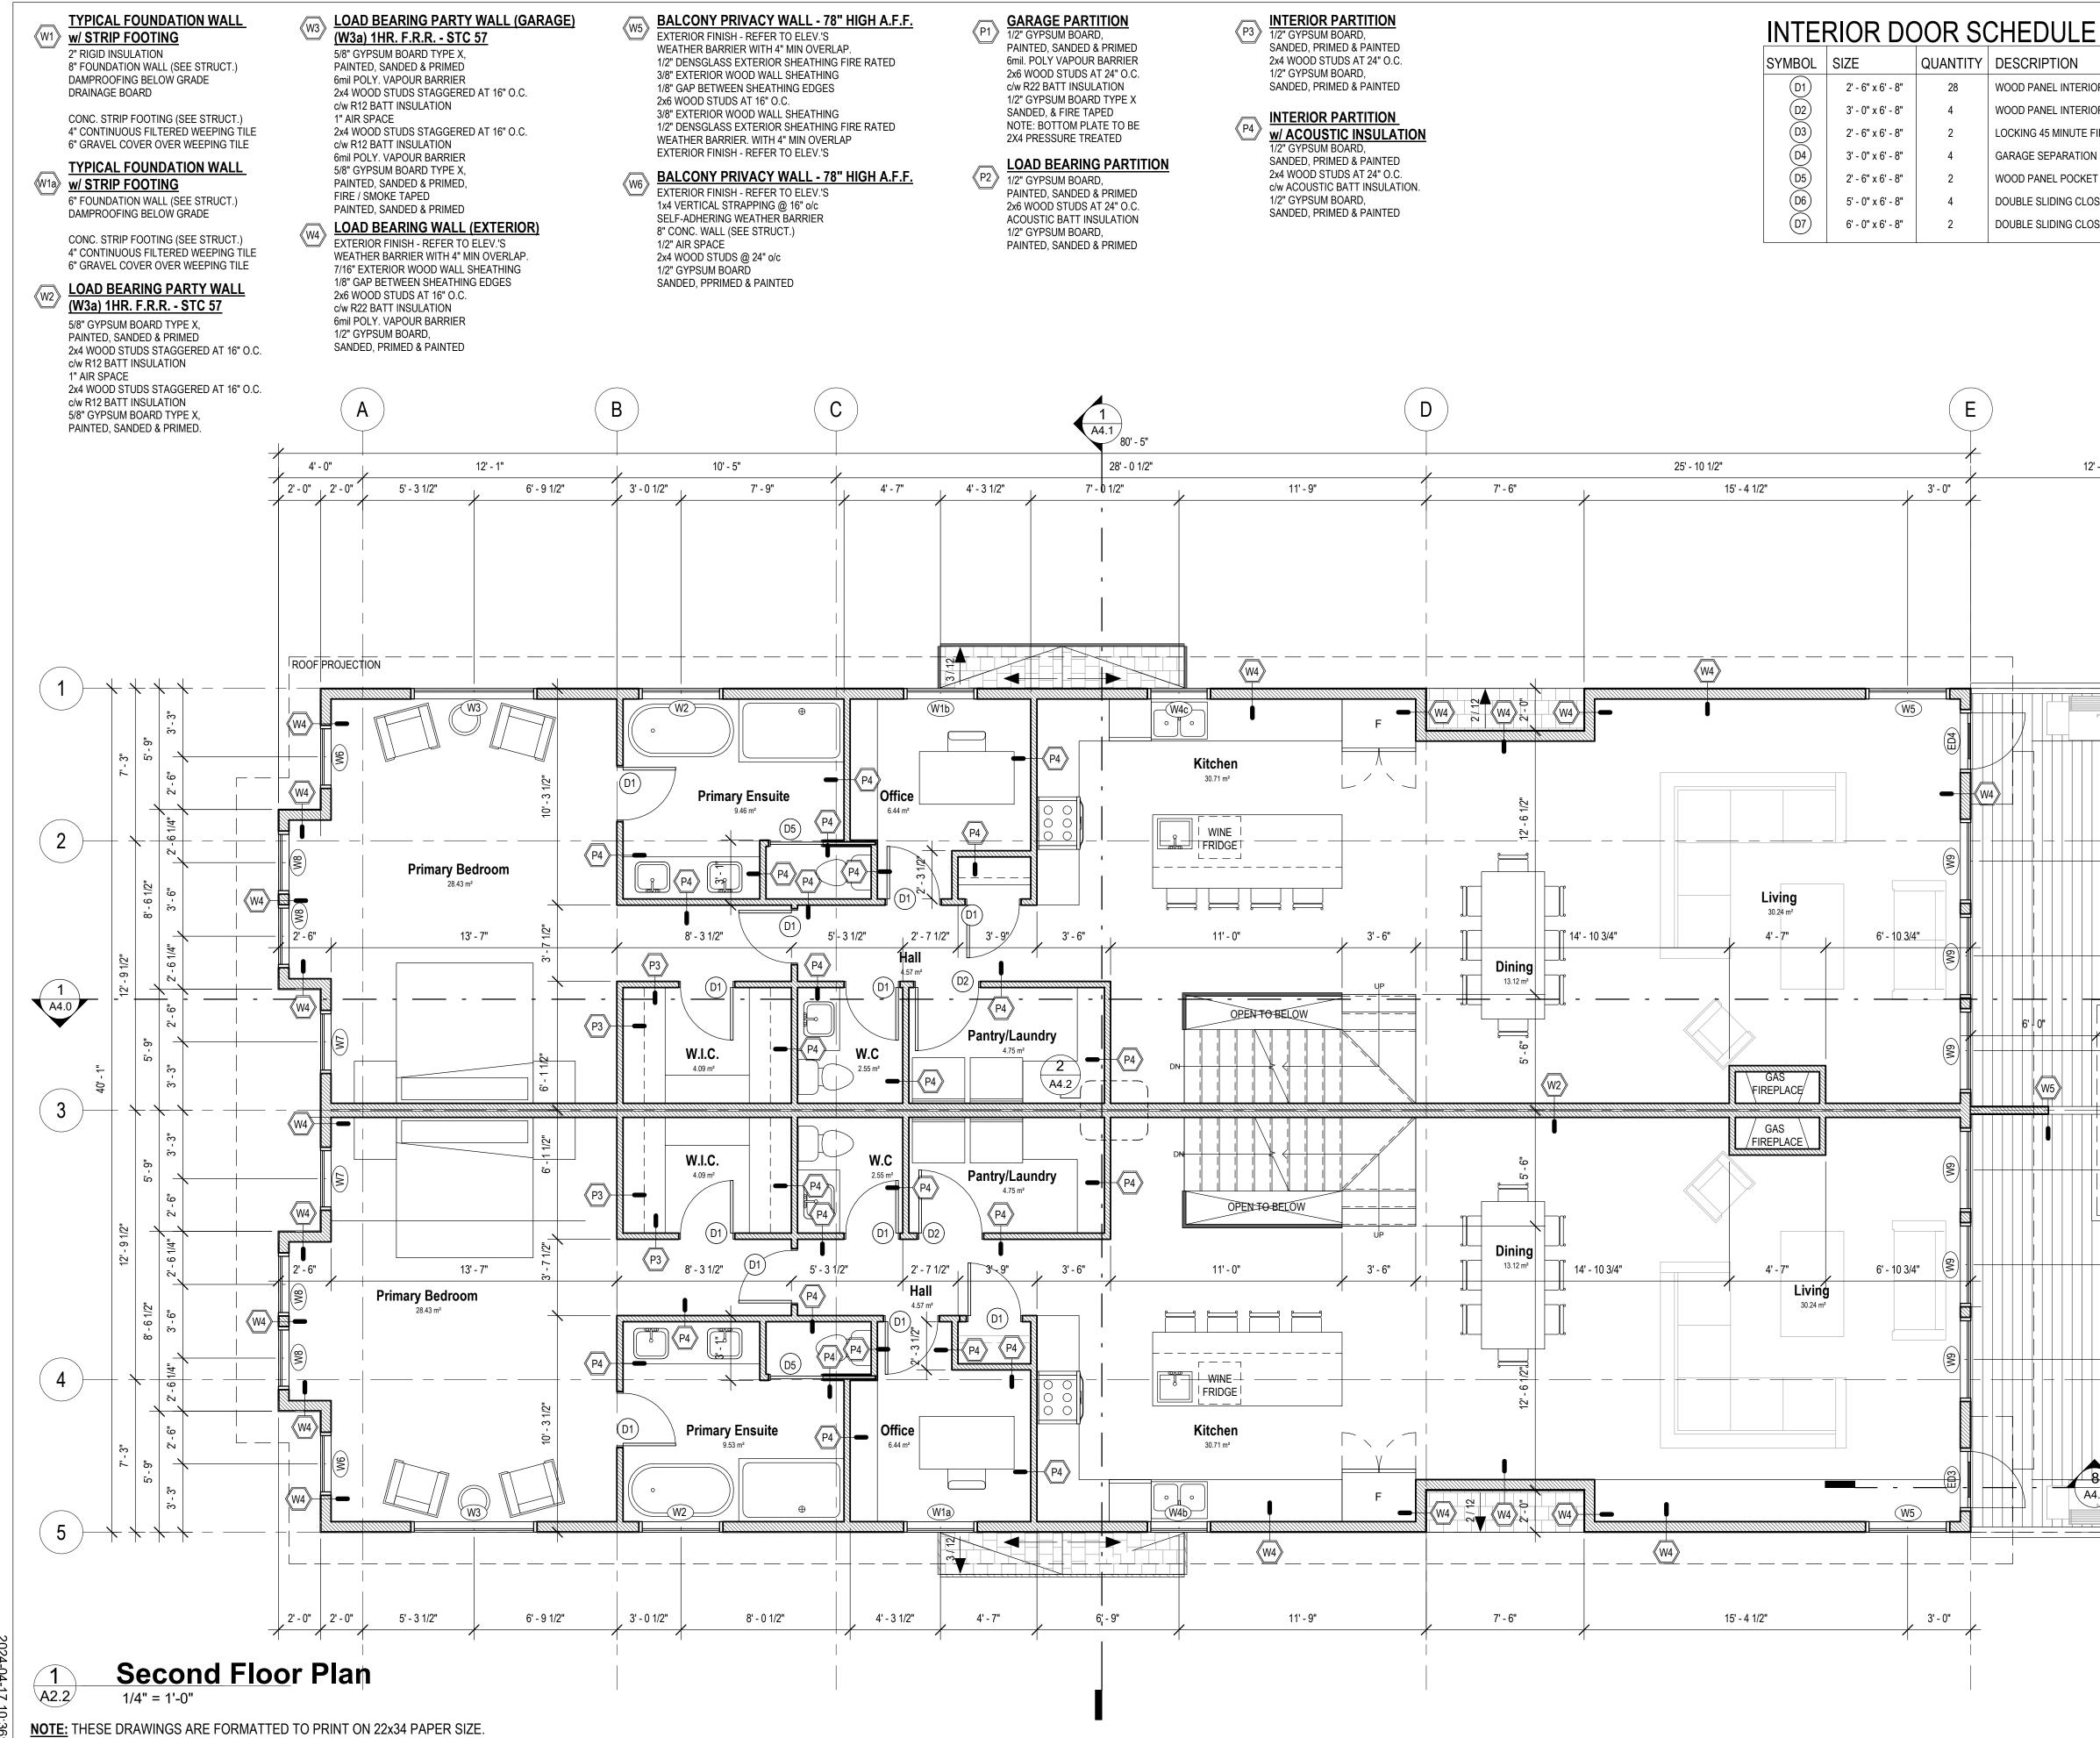6' - 0" **W5** 

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SYMBOL	SIZE	QUANTITY	DESCRIPTION	WALL SIZE
(D1)	2' - 6" x 6' - 8"	28	WOOD PANEL INTERIOR DOOR	2 X 4
D2	3' - 0" x 6' - 8"	4	WOOD PANEL INTERIOR DOOR	2 X 4
D3	2' - 6" x 6' - 8"	2	LOCKING 45 MINUTE FIRE RATED INTERIOR DOOR	2 X 4
D4)	3' - 0" x 6' - 8"	4	GARAGE SEPARATION DOOR w/ SELF CLOSER AND SMOKE SEAL	2 X 6
D5	2' - 6" x 6' - 8"	2	WOOD PANEL POCKET DOOR	2 X 4
D6)	5' - 0" x 6' - 8"	4	DOUBLE SLIDING CLOSET DOOR-WOOD PANEL	2 X 4
D7	6' - 0" x 6' - 8"	2	DOUBLE SLIDING CLOSET DOOR-WOOD PANEL	2 X 4
				i



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6.	BP	2023-04-13
7.	DP	2023-06-26
8.	Revised DP	2023-08-23
9.	Revised BP	2023-09-11
10.	Revised BP	2023-09-28
11.	IFC	2023-10-09
12.	ID Revisions	2024-03-21
13.	Revised IFC	2024-04-02

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# Loft Floor Plan

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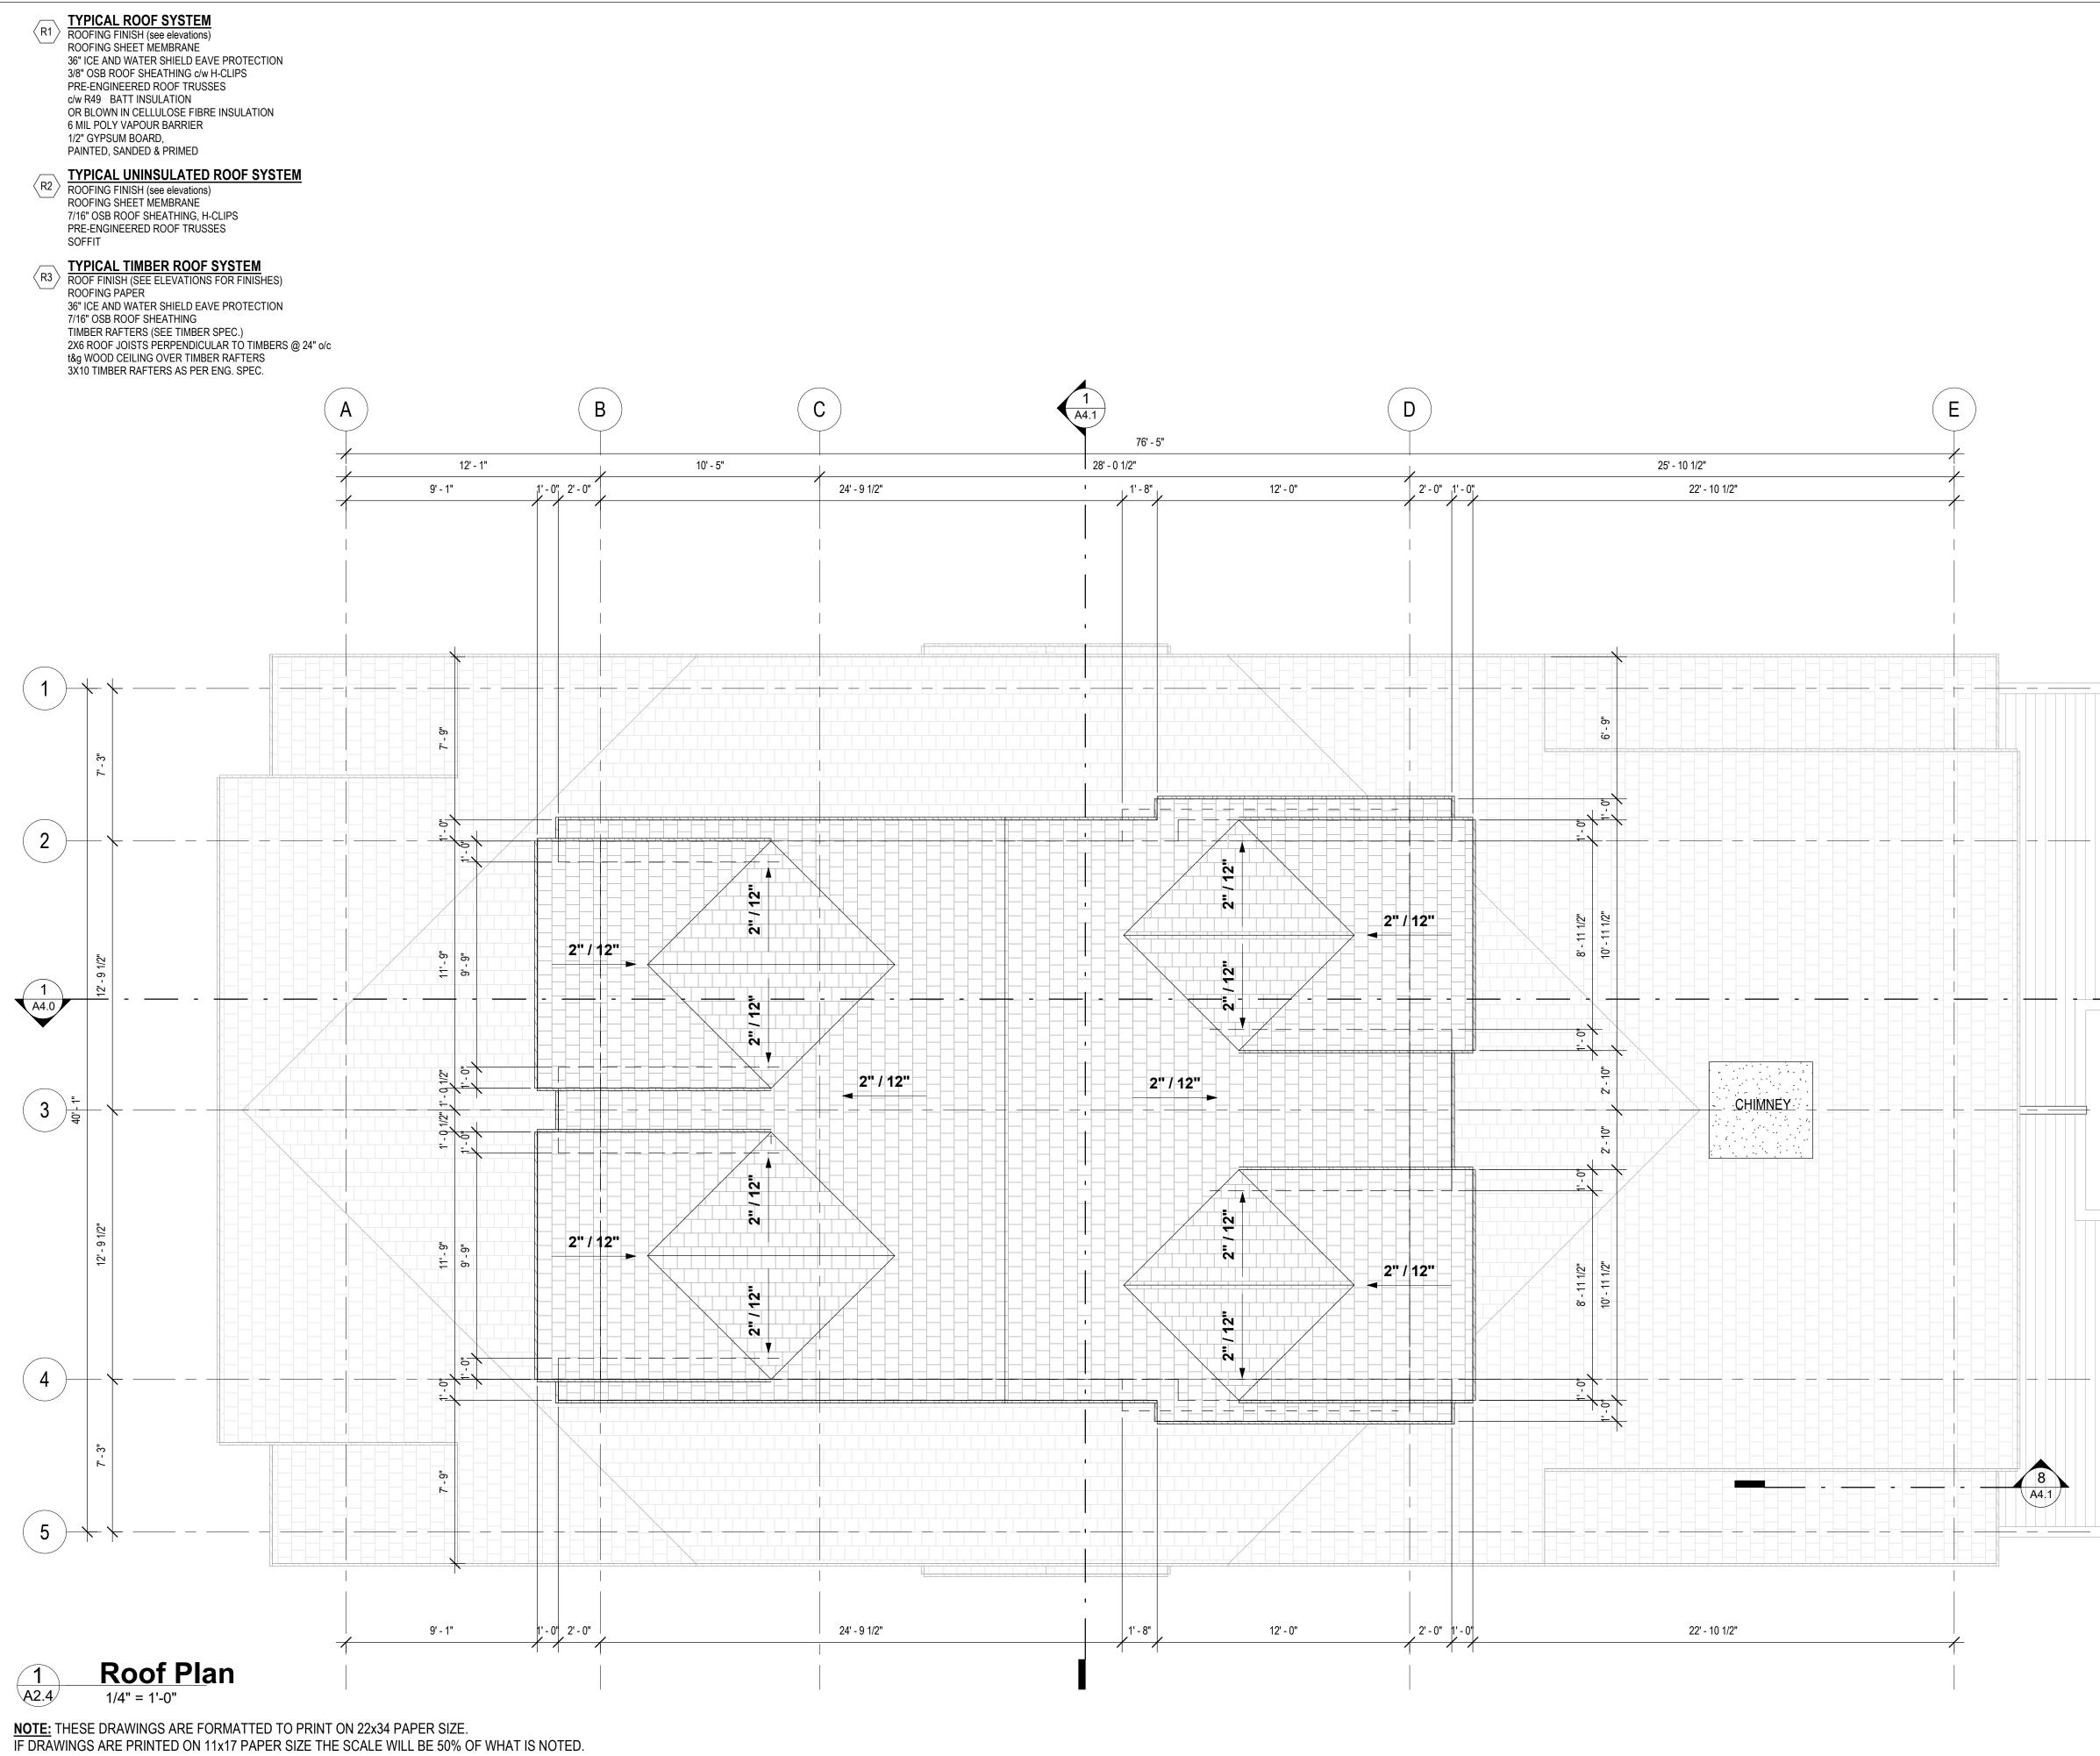
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12.	ID Revisions	2024-03-21

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# Roof Plan

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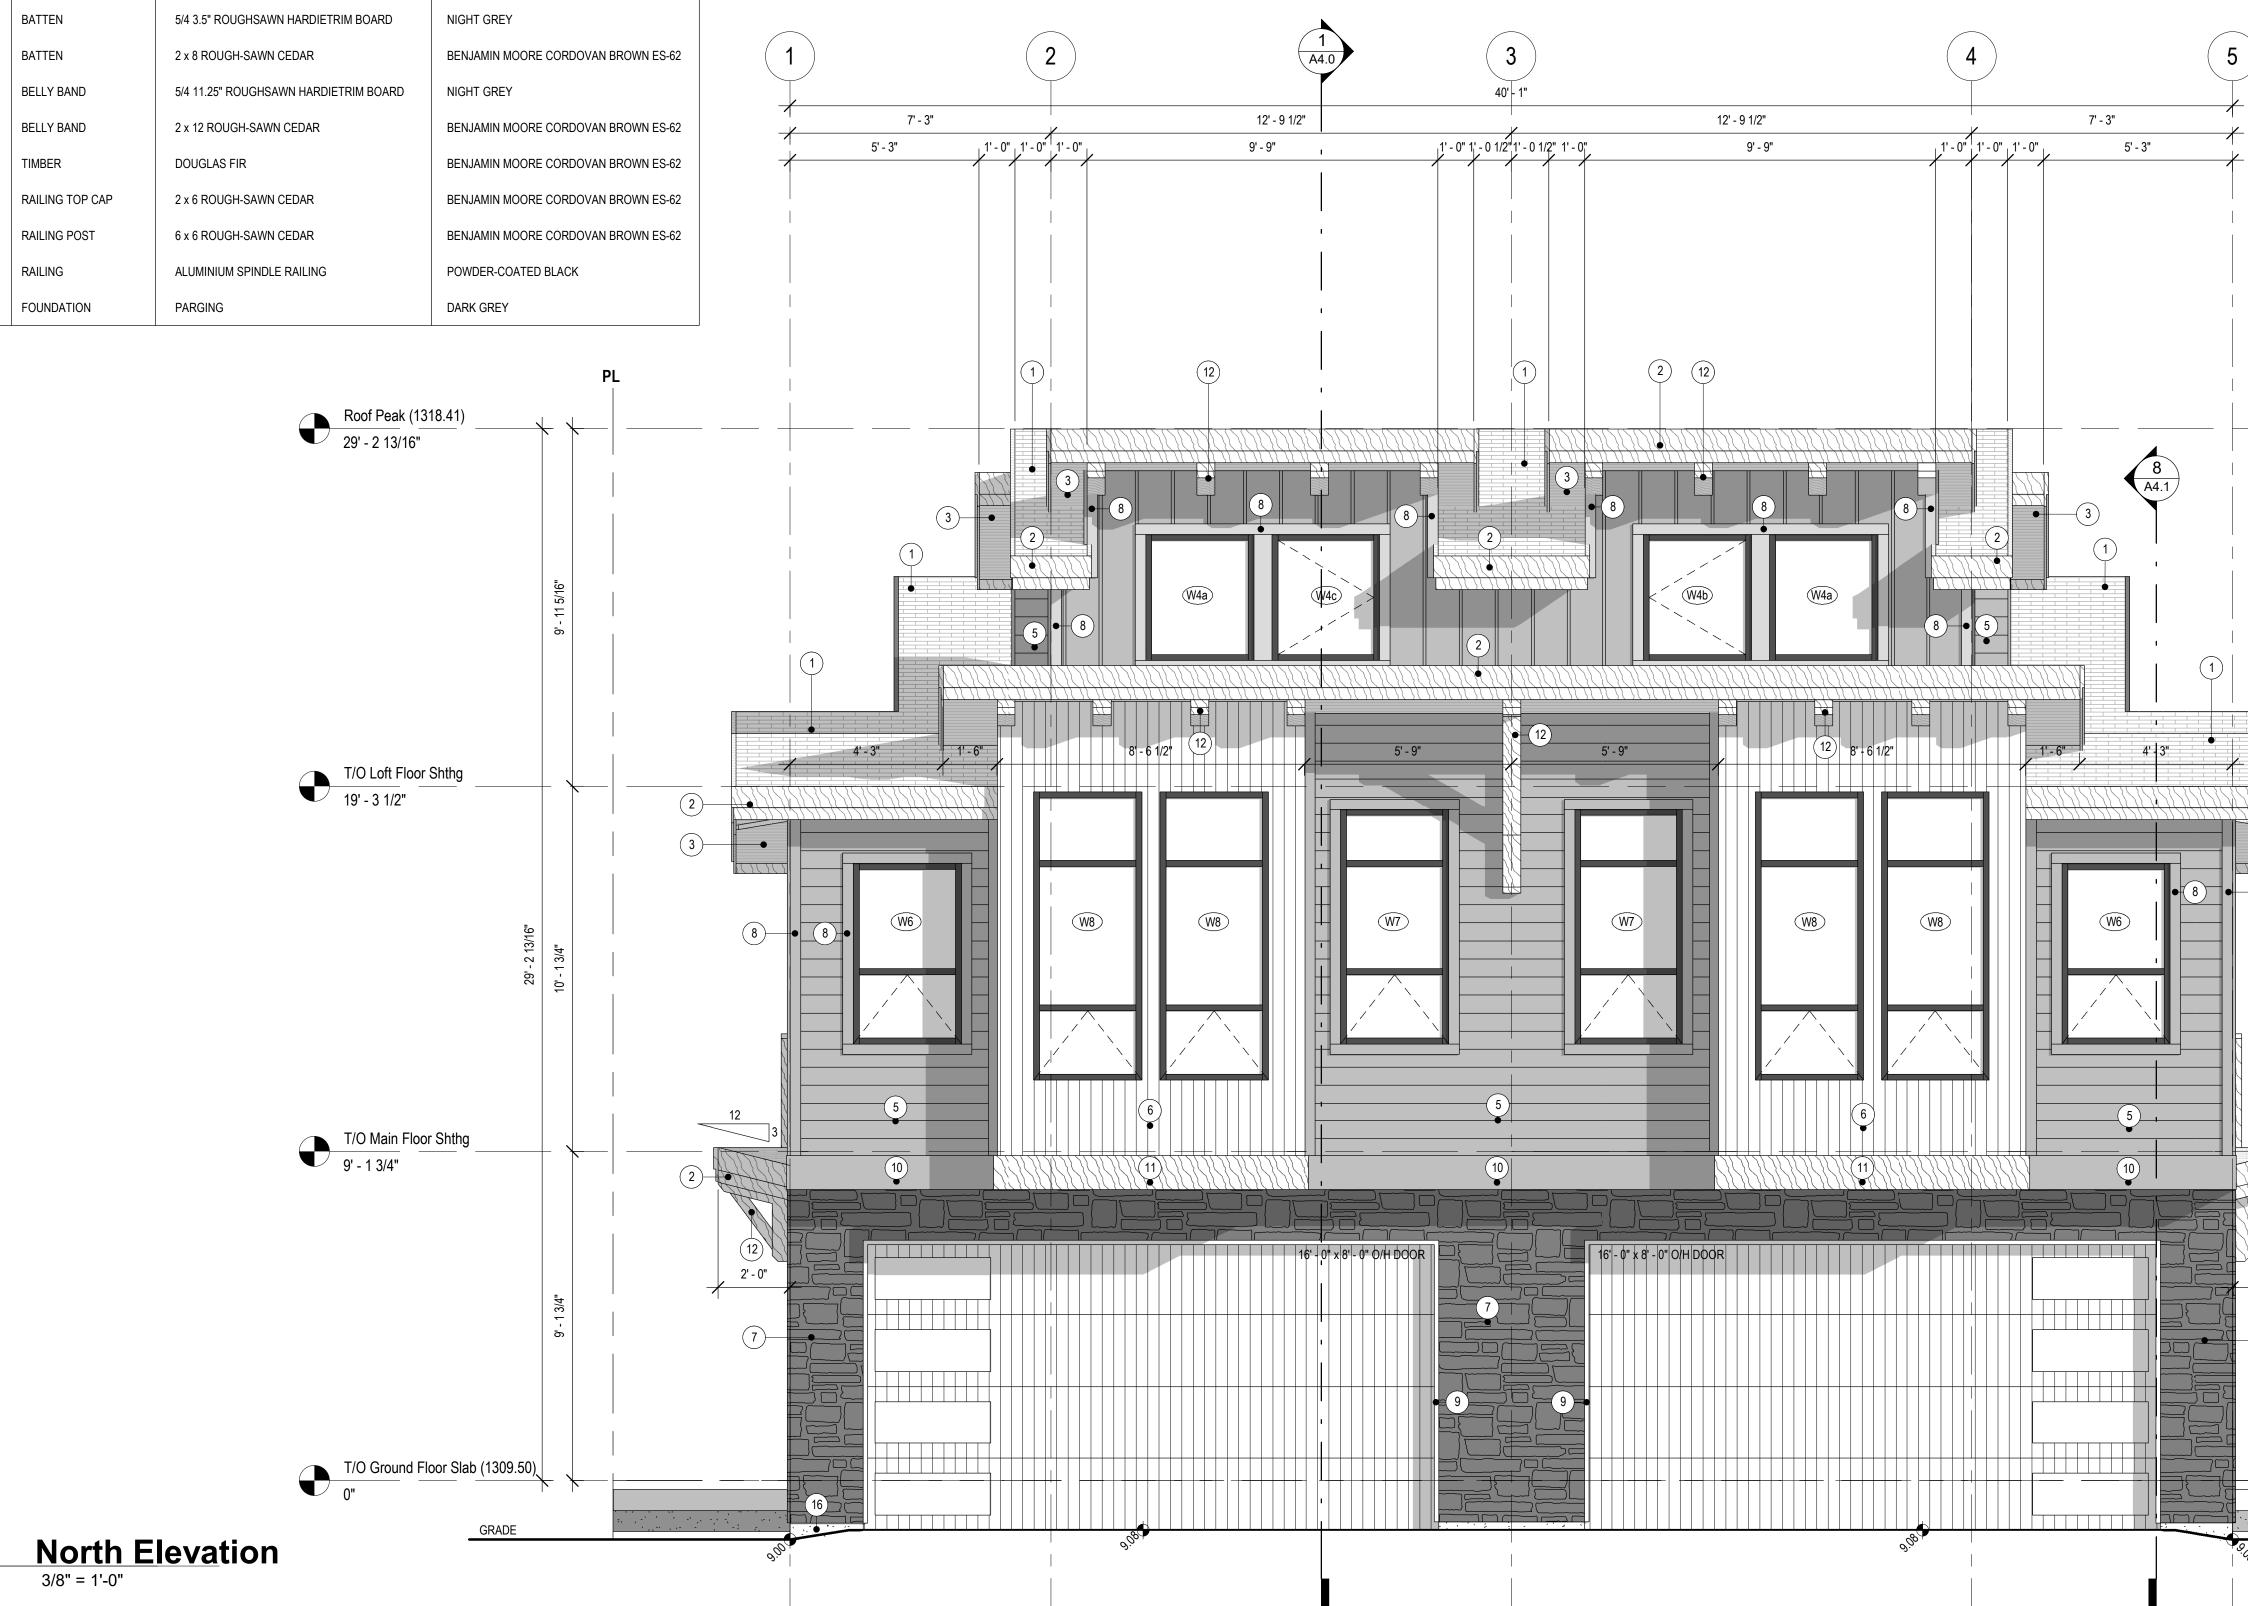
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# EXTERIOR FINISH SCHEDULE

SYMBOL	COMPONENT	MATERIAL	FINISH	
	ROOFING	FIBERGLASS SHINGLES	BLACK	
2	STEPPED FASCIA	9 1/4"- 5 1/2" CEDAR	BENJAMIN MOORE CORDOVAN BROWN ES-62	
3	SOFFIT	3 1/2" CEDAR T&G	BENJAMIN MOORE CORDOVAN BROWN ES-62	
4	SIDING	HARDIE BOARD AND BATTEN	NIGHT GREY	
5	SIDING	HARDIE LAPSIDING	NIGHT GREY	
6	SIDING	3 1/2" VERTICAL CEDAR T&G SIDING	BENJAMIN MOORE CORDOVAN BROWN ES-62	
7	SIDING	STONE	RUNDLE STONE	
8	BATTEN	5/4 3.5" ROUGHSAWN HARDIETRIM BOARD	NIGHT GREY	
9	BATTEN	2 x 8 ROUGH-SAWN CEDAR	BENJAMIN MOORE CORDOVAN BROWN ES-62	
10	BELLY BAND	5/4 11.25" ROUGHSAWN HARDIETRIM BOARD	NIGHT GREY	
(11)	BELLY BAND	2 x 12 ROUGH-SAWN CEDAR	BENJAMIN MOORE CORDOVAN BROWN ES-62	7' - 3"
(12)	TIMBER	DOUGLAS FIR	BENJAMIN MOORE CORDOVAN BROWN ES-62	5' - 3" 1' - 0"
(13)	RAILING TOP CAP	2 x 6 ROUGH-SAWN CEDAR	BENJAMIN MOORE CORDOVAN BROWN ES-62	
14	RAILING POST	6 x 6 ROUGH-SAWN CEDAR	BENJAMIN MOORE CORDOVAN BROWN ES-62	
(15)	RAILING	ALUMINIUM SPINDLE RAILING	POWDER-COATED BLACK	
(16)	FOUNDATION	PARGING	DARK GREY	



NOTE: THESE DRAWINGS ARE FORMATTED TO PRINT ON 22x34 PAPER SIZE. IF DRAWINGS ARE PRINTED ON 11x17 PAPER SIZE THE SCALE WILL BE 50% OF WHAT IS NOTED.

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CLIENT NAME lan Sarna and Richard Greaves

PROJECT NAME

## 721 Duplex

721 3rd Street Canmore, Alberta

DRAWING TITLE

# North Elevation

DRAWN BY:QM

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-3

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•

-8

3

12

2' - 0"

-7


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PROJECT NUMBER 386-22

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# EXTERIOR FINISH SCHEDULE

SYMBOL	COMPONENT	MATERIAL	FINISH
1	ROOFING	FIBERGLASS SHINGLES	BLACK
2	STEPPED FASCIA	9 1/4"- 5 1/2" CEDAR	BENJAMIN MOORE CORDOVAN BROWN ES-62
3	SOFFIT	3 1/2" CEDAR T&G	BENJAMIN MOORE CORDOVAN BROWN ES-62
4	SIDING	HARDIE BOARD AND BATTEN	NIGHT GREY
5	SIDING	HARDIE LAPSIDING	NIGHT GREY
6	SIDING	3 1/2" VERTICAL CEDAR T&G SIDING	BENJAMIN MOORE CORDOVAN BROWN ES-62
7	SIDING	STONE	RUNDLE STONE
8	BATTEN	5/4 3.5" ROUGHSAWN HARDIETRIM BOARD	NIGHT GREY
9	BATTEN	2 x 8 ROUGH-SAWN CEDAR	BENJAMIN MOORE CORDOVAN BROWN ES-62
(10)	BELLY BAND	5/4 11.25" ROUGHSAWN HARDIETRIM BOARD	NIGHT GREY
(11)	BELLY BAND	2 x 12 ROUGH-SAWN CEDAR	BENJAMIN MOORE CORDOVAN BROWN ES-62
(12)	TIMBER	DOUGLAS FIR	BENJAMIN MOORE CORDOVAN BROWN ES-62
(13)	RAILING TOP CAP	2 x 6 ROUGH-SAWN CEDAR	BENJAMIN MOORE CORDOVAN BROWN ES-62
14	RAILING POST	6 x 6 ROUGH-SAWN CEDAR	BENJAMIN MOORE CORDOVAN BROWN ES-62
(15)	RAILING	ALUMINIUM SPINDLE RAILING	POWDER-COATED BLACK
(16)	FOUNDATION	PARGING	DARK GREY




NOTE: THESE DRAWINGS ARE FORMATTED TO PRINT ON 22x34 PAPER SIZE. IF DRAWINGS ARE PRINTED ON 11x17 PAPER SIZE THE SCALE WILL BE 50% OF WHAT IS NOTED.
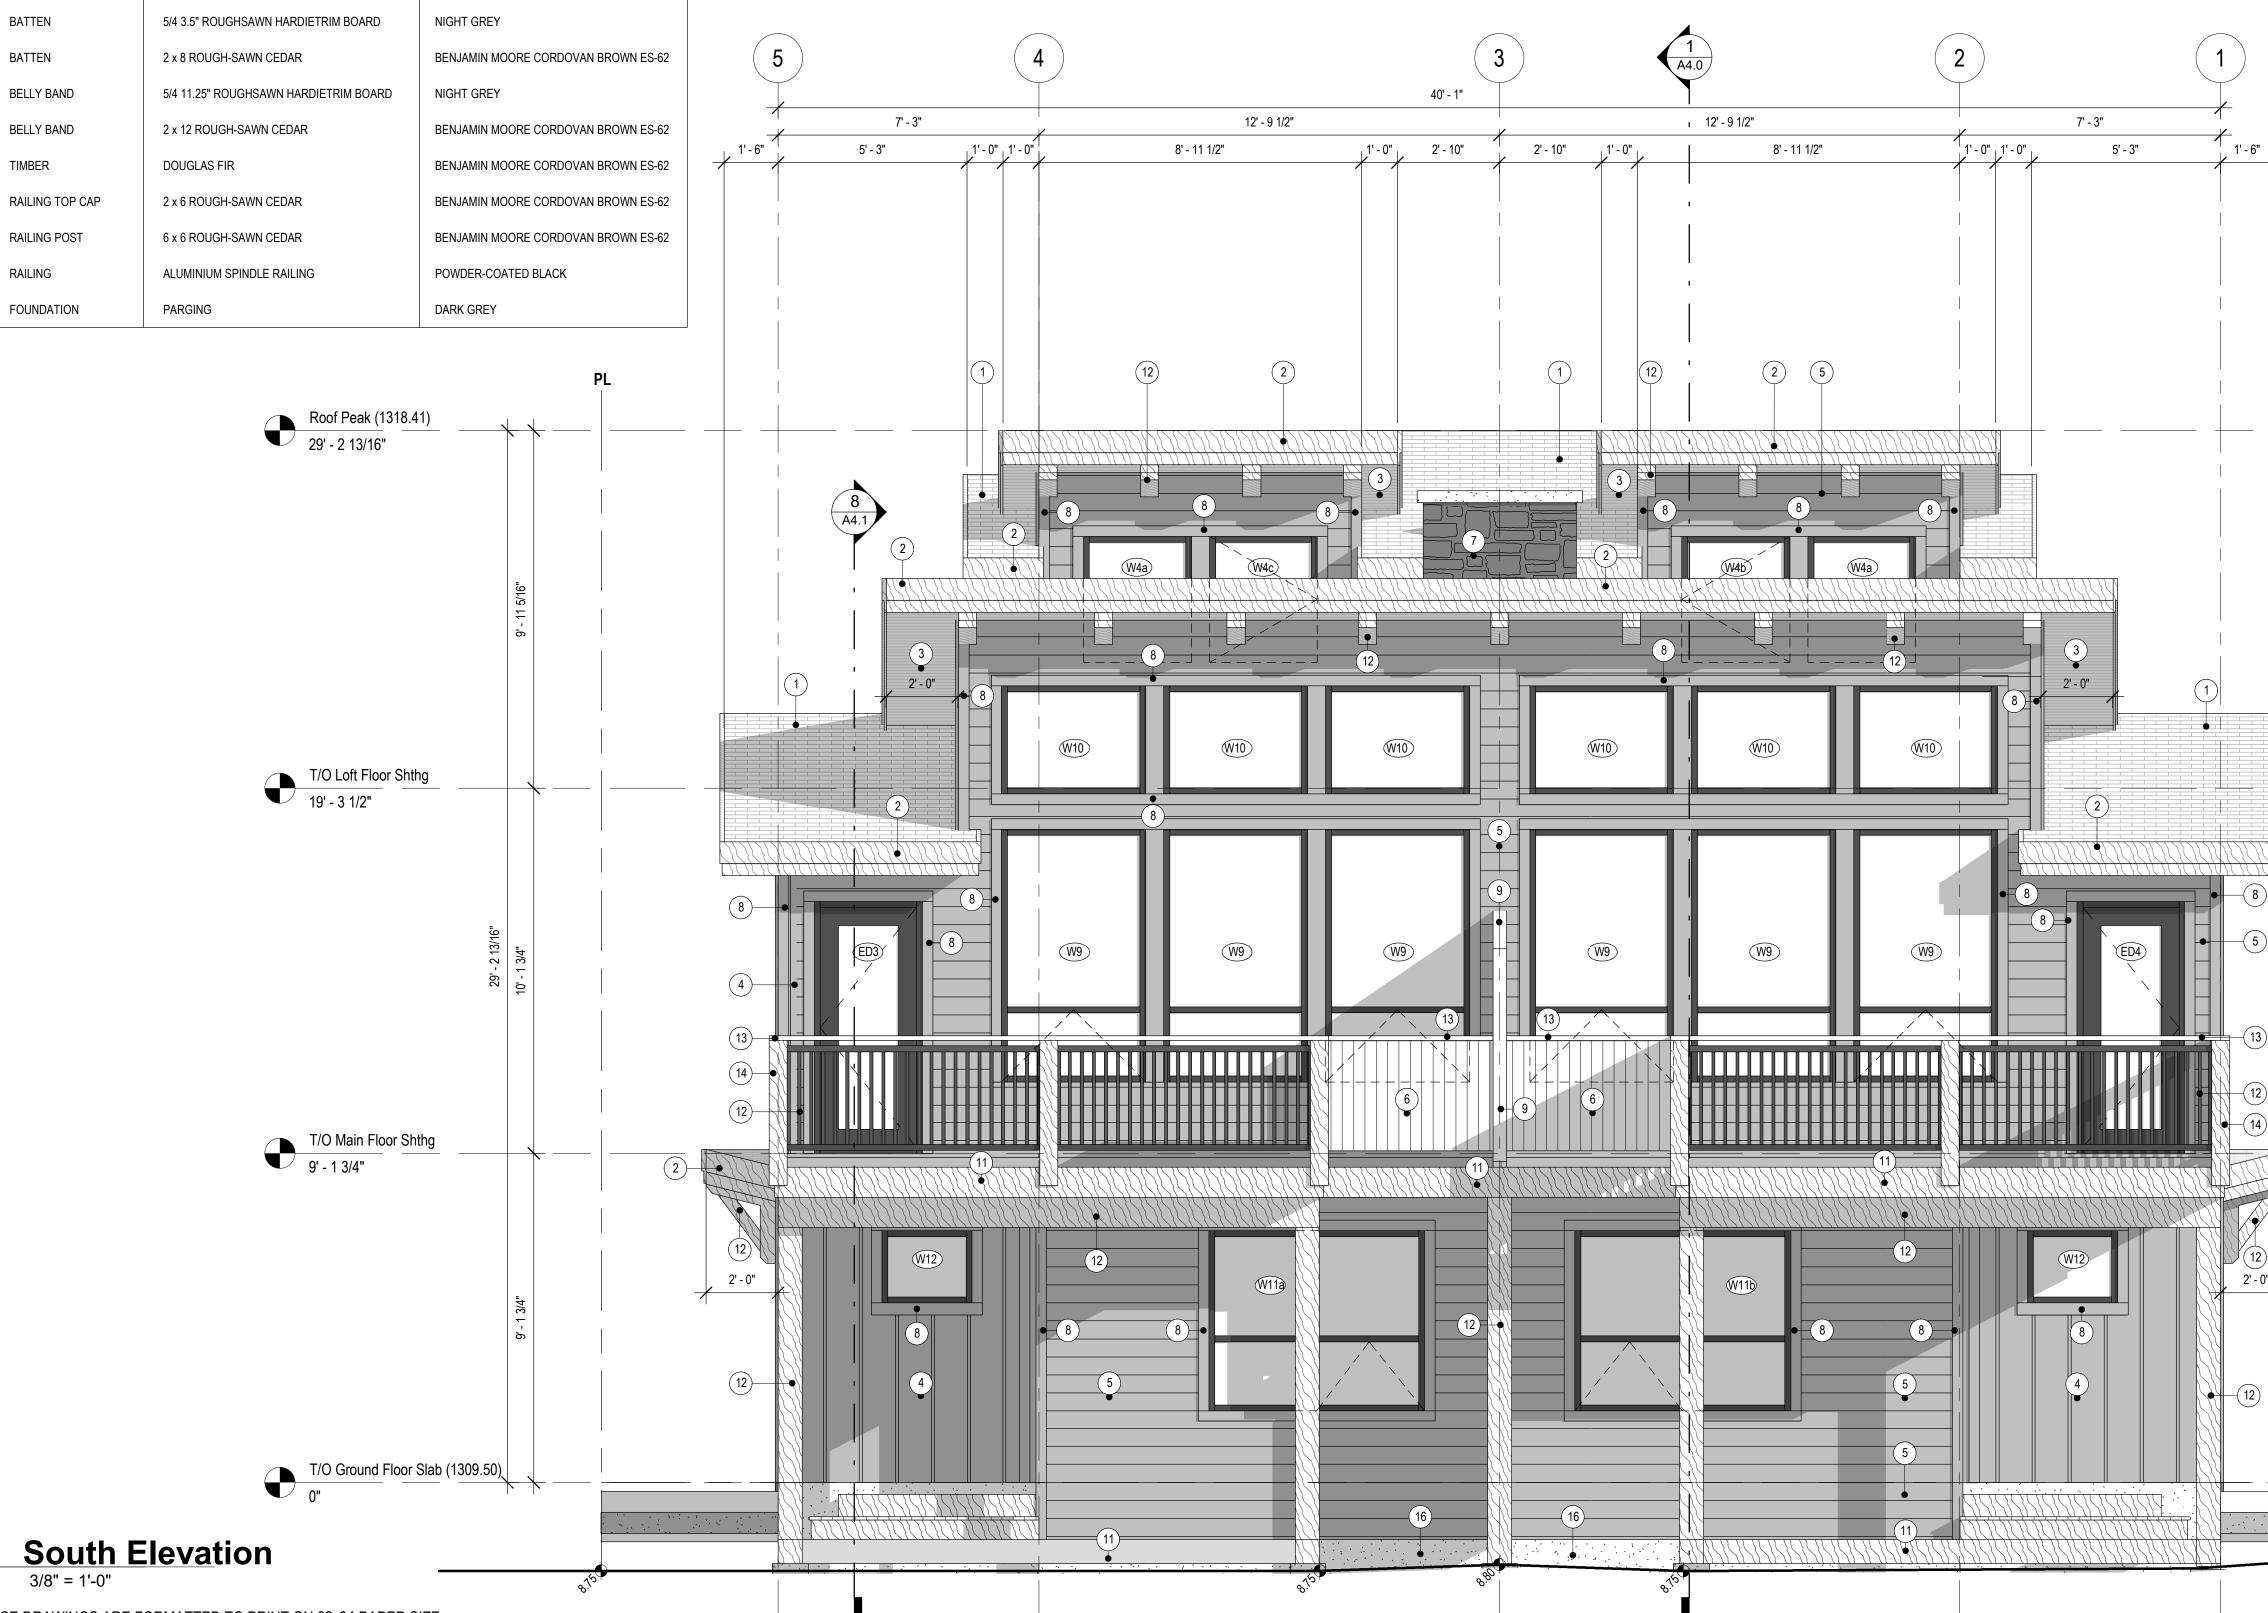
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A3.1



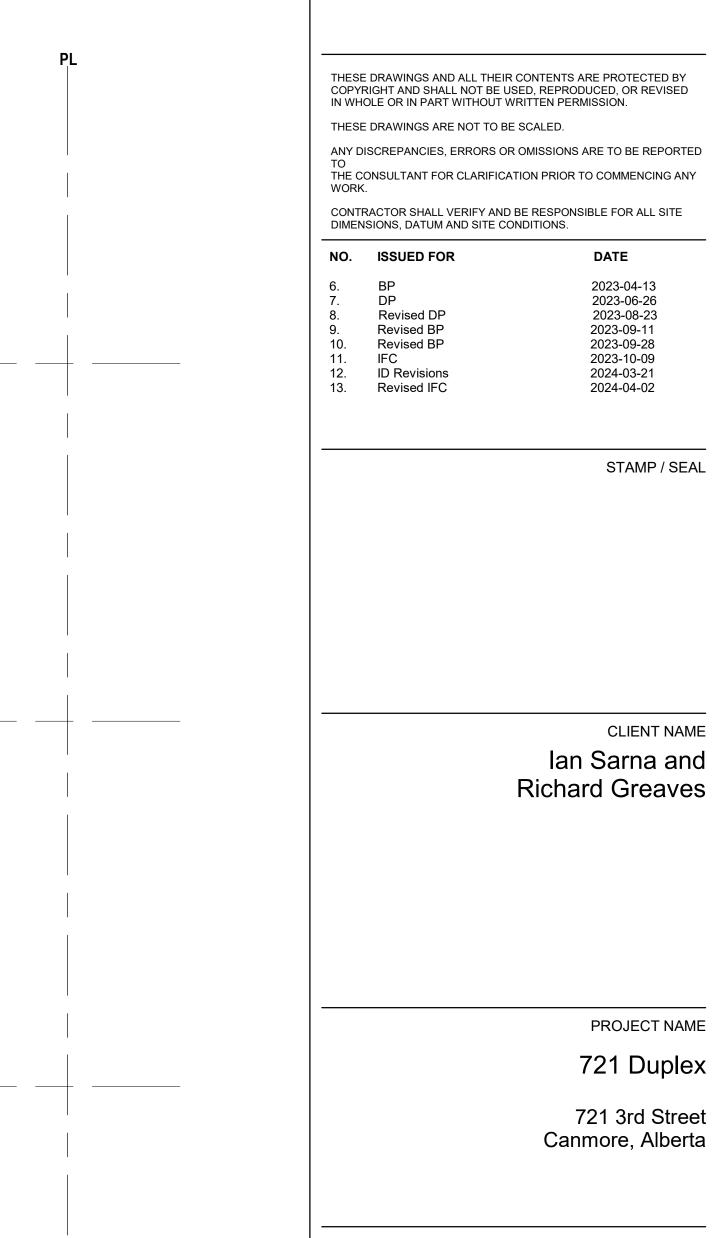

1' - 6"

- (5)

(13)

(12)

(14)

12 2' - 0"

DRAWING TITLE

# South Elevation

DRAWN BY:QM


CHECKED BY: SM

PROJECT NUMBER 386-22

SHEET NO

2024-04-17 10:37:41 AM A3.1

SYMBOL	COMPONENT	MATERIAL	FINISH	Loft Floor Wall: Limiting Distance: 3.7
(1)	ROOFING	FIBERGLASS SHINGLES	BLACK	Allowable Unprotected
2	STEPPED FASCIA	9 1/4"- 5 1/2" CEDAR	BENJAMIN MOORE CORDOVAN BROWN ES-62	Area Of Exposed Buil Allowable Unprotected Proposed Unprotected
3	SOFFIT	3 1/2" CEDAR T&G	BENJAMIN MOORE CORDOVAN BROWN ES-62	Ground/Second Floor
4	SIDING	HARDIE BOARD AND BATTEN	NIGHT GREY	Limiting Distance: 1.5 Allowable Unprotected
5	SIDING	HARDIE LAPSIDING	NIGHT GREY	Area Of Exposed Buil Allowable Unprotected
6	SIDING	3 1/2" VERTICAL CEDAR T&G SIDING	BENJAMIN MOORE CORDOVAN BROWN ES-62	Proposed Unprotected
7	SIDING	STONE	RUNDLE STONE	<u>Ground/Second Floor</u> Limiting Distance: 2.0 Allowable Unprotected
8	BATTEN	5/4 3.5" ROUGHSAWN HARDIETRIM BOARD	NIGHT GREY	Area Of Exposed Buil
9	BATTEN	2 x 8 ROUGH-SAWN CEDAR	BENJAMIN MOORE CORDOVAN BROWN ES-62	Allowable Unprotected Proposed Unprotected
(10)	BELLY BAND	5/4 11.25" ROUGHSAWN HARDIETRIM BOARD	NIGHT GREY	
(11)	BELLY BAND	2 x 12 ROUGH-SAWN CEDAR	BENJAMIN MOORE CORDOVAN BROWN ES-62	
(12)	TIMBER	DOUGLAS FIR	BENJAMIN MOORE CORDOVAN BROWN ES-62	
(13)	RAILING TOP CAP	2 x 6 ROUGH-SAWN CEDAR	BENJAMIN MOORE CORDOVAN BROWN ES-62	
(14)	RAILING POST	6 x 6 ROUGH-SAWN CEDAR	BENJAMIN MOORE CORDOVAN BROWN ES-62	
(15)	RAILING	ALUMINIUM SPINDLE RAILING	POWDER-COATED BLACK	
(16)	FOUNDATION	PARGING	DARK GREY	

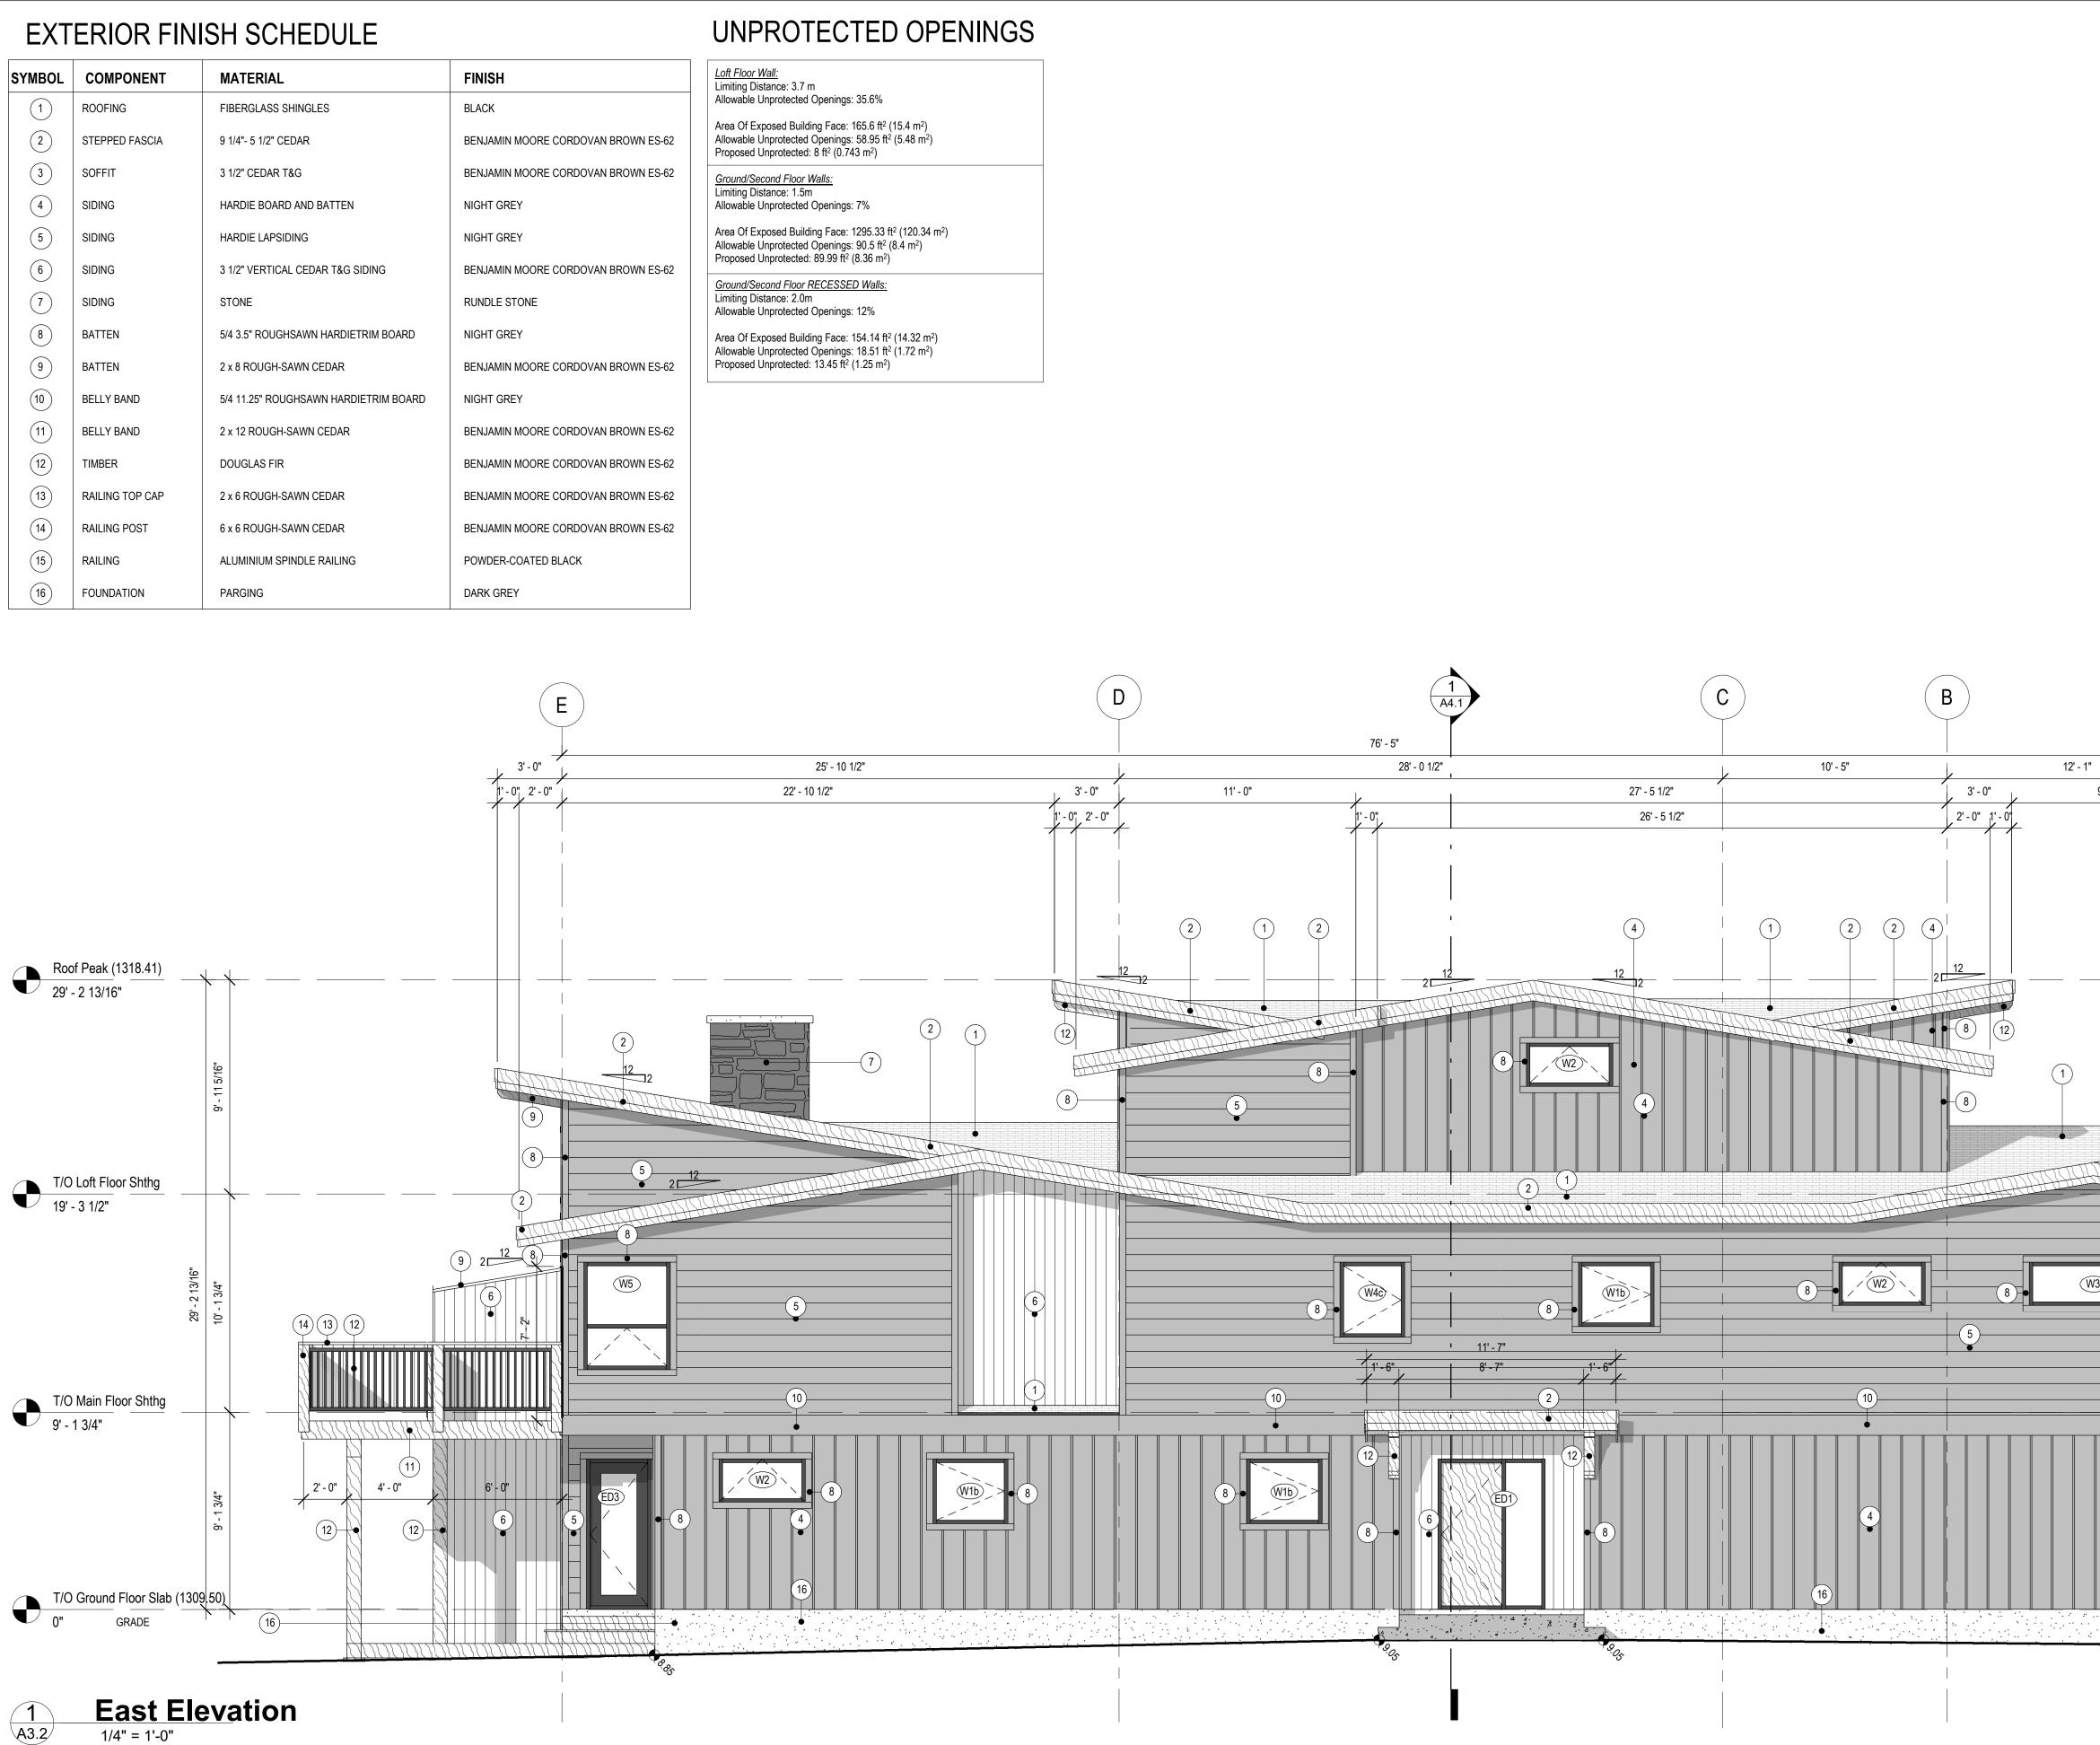

# 1/4" = 1'-0"

NOTE: THESE DRAWINGS ARE FORMATTED TO PRINT ON 22x34 PAPER SIZE. IF DRAWINGS ARE PRINTED ON 11x17 PAPER SIZE THE SCALE WILL BE 50% OF WHAT IS NOTED.



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CONTRACTOR SHALL VERIFY AND BE RESPONSIBLE FOR ALL SITE DIMENSIONS, DATUM AND SITE CONDITIONS.

	·				
NO.	ISSUED FOR	DATE			
6.	BP	2023-04-13			
7.	DP	2023-06-26			
8.	Revised DP	2023-08-23			
9.	Revised BP	2023-09-11			
10.	Revised BP	2023-09-28			
11.	IFC	2023-10-09			
12.	ID Revisions	2024-03-21			
13.	Revised IFC	2024-04-02			

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STAMP / SEAL
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CLIENT NAME lan Sarna and Richard Greaves

PROJECT NAME

### 721 Duplex

721 3rd Street Canmore, Alberta

DRAWING TITLE

# East Elevation

DRAWN BY:QM

PROJECT NUMBER 386-22

SHEET NO

CHECKED BY: SM

A3.2 2024-05-08 8:21:57 AM

2 2 2 W3 ─(8)≠ • 0.00 (10)-(7)

А

9' - 1"


6' - 0"


2' - 0"

4' - 0"


2'-0" 2'-0"


SYMBOL	COMPONENT	MATERIAL	FINISH	Loft Floor Wall
	ROOFING	FIBERGLASS SHINGLES	BLACK	Allowable Unp
2	STEPPED FASCIA	9 1/4"- 5 1/2" CEDAR	BENJAMIN MOORE CORDOVAN BROWN ES-62	Area Of Expos Allowable Unp Proposed Unp
3	SOFFIT	3 1/2" CEDAR T&G	BENJAMIN MOORE CORDOVAN BROWN ES-62	Ground/Secon
4	SIDING	HARDIE BOARD AND BATTEN	NIGHT GREY	Limiting Distar Allowable Unp
5	SIDING	HARDIE LAPSIDING	NIGHT GREY	Area Of Expos Allowable Unp Proposed Unp
6	SIDING	3 1/2" VERTICAL CEDAR T&G SIDING	BENJAMIN MOORE CORDOVAN BROWN ES-62	Ground/Secon
7	SIDING	STONE	RUNDLE STONE	Limiting Distar
8	BATTEN	5/4 3.5" ROUGHSAWN HARDIETRIM BOARD	NIGHT GREY	Area Of Expos
9	BATTEN	2 x 8 ROUGH-SAWN CEDAR	BENJAMIN MOORE CORDOVAN BROWN ES-62	Allowable Unp Proposed Unp
(10)	BELLY BAND	5/4 11.25" ROUGHSAWN HARDIETRIM BOARD	NIGHT GREY	
(11)	BELLY BAND	2 x 12 ROUGH-SAWN CEDAR	BENJAMIN MOORE CORDOVAN BROWN ES-62	
(12)	TIMBER	DOUGLAS FIR	BENJAMIN MOORE CORDOVAN BROWN ES-62	
(13)	RAILING TOP CAP	2 x 6 ROUGH-SAWN CEDAR	BENJAMIN MOORE CORDOVAN BROWN ES-62	
(14)	RAILING POST	6 x 6 ROUGH-SAWN CEDAR	BENJAMIN MOORE CORDOVAN BROWN ES-62	
(15)	RAILING	ALUMINIUM SPINDLE RAILING	POWDER-COATED BLACK	
(16)	FOUNDATION	PARGING	DARK GREY	

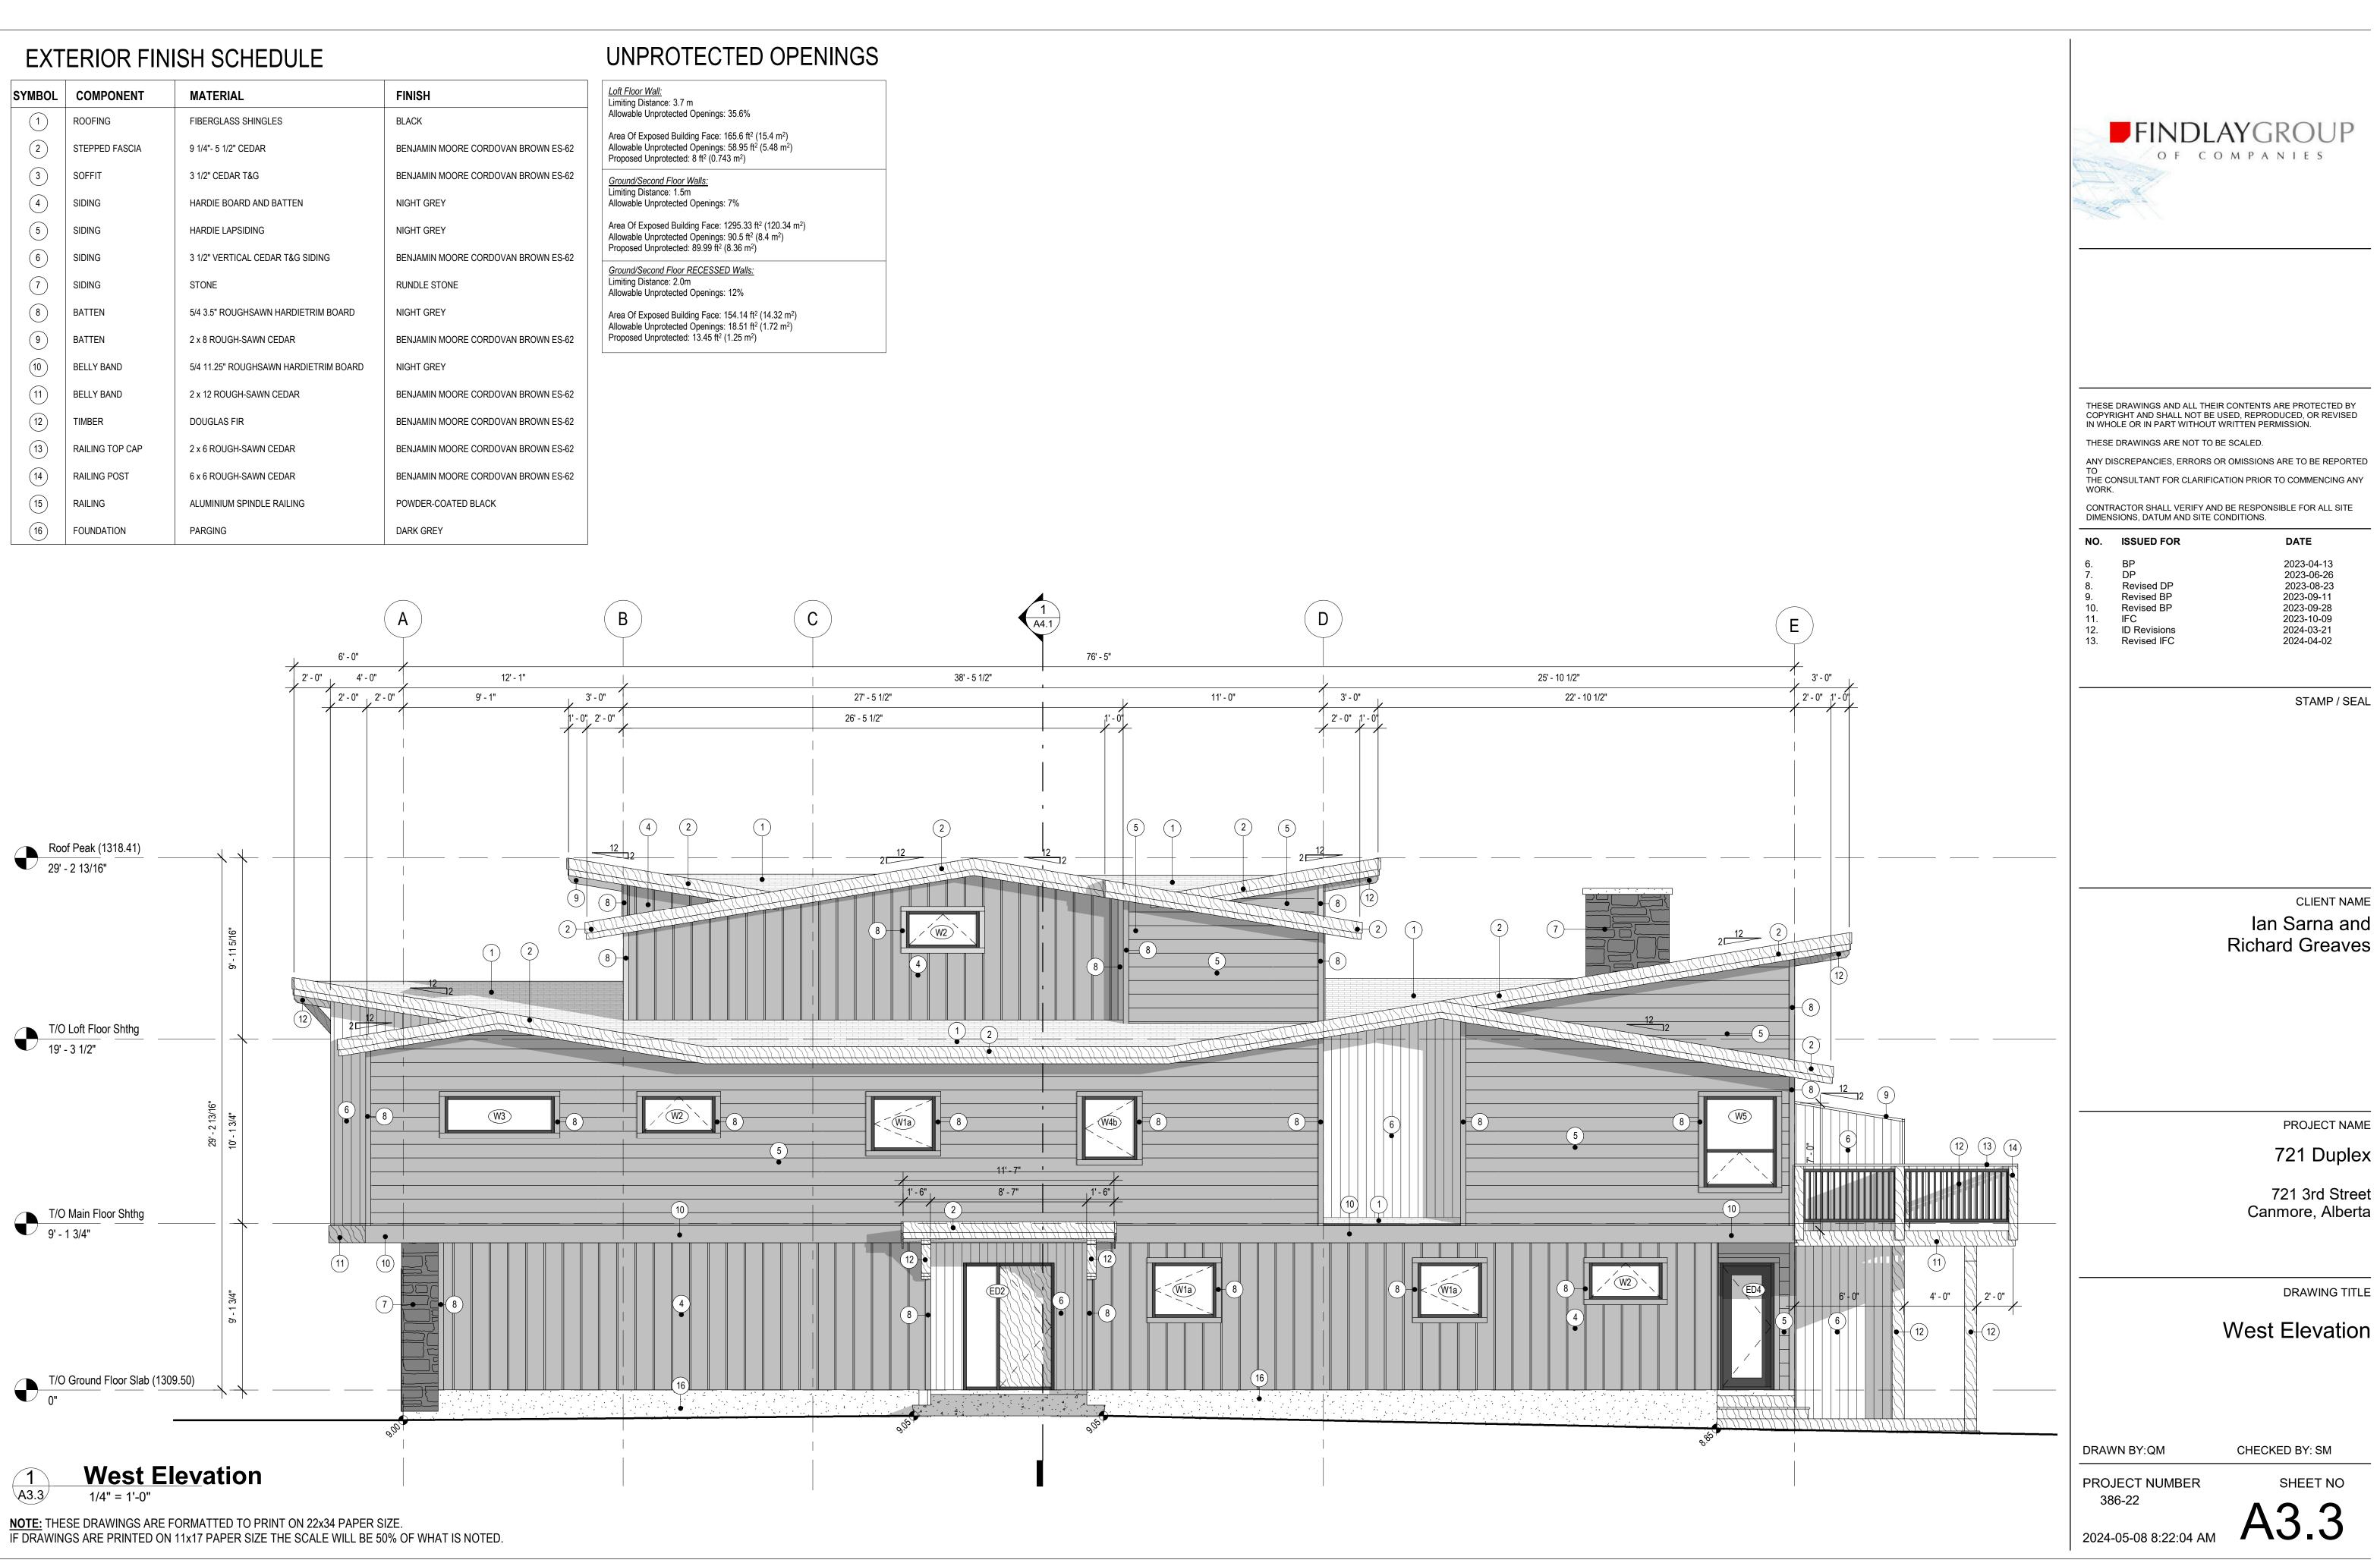


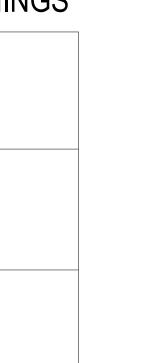

# WINDOW AND EXTERIOR DOOR DIAGRAM

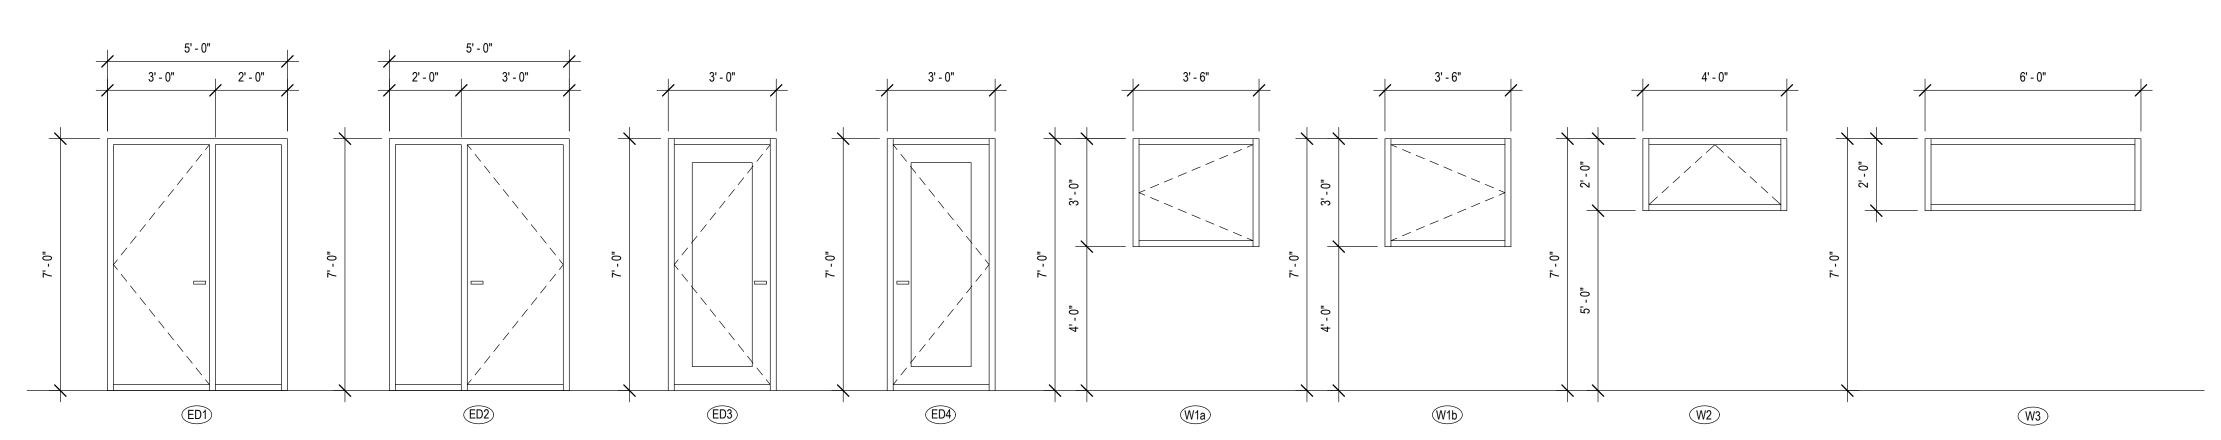

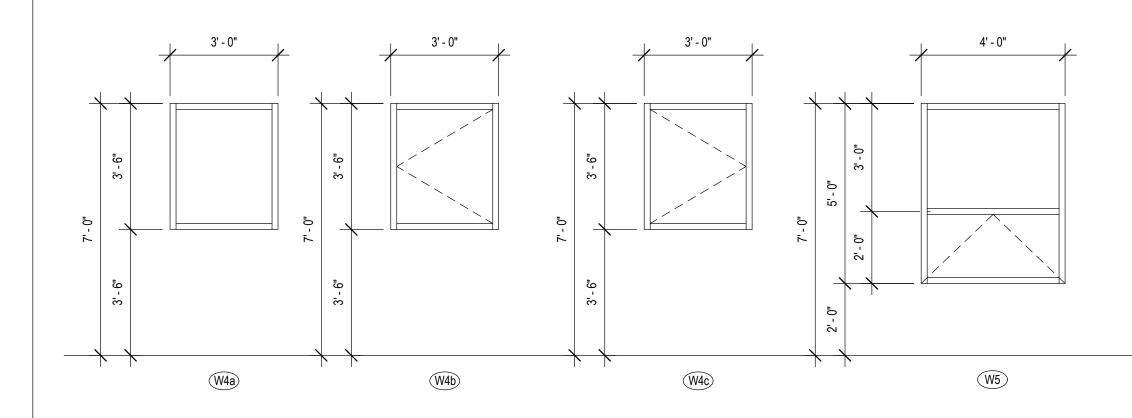

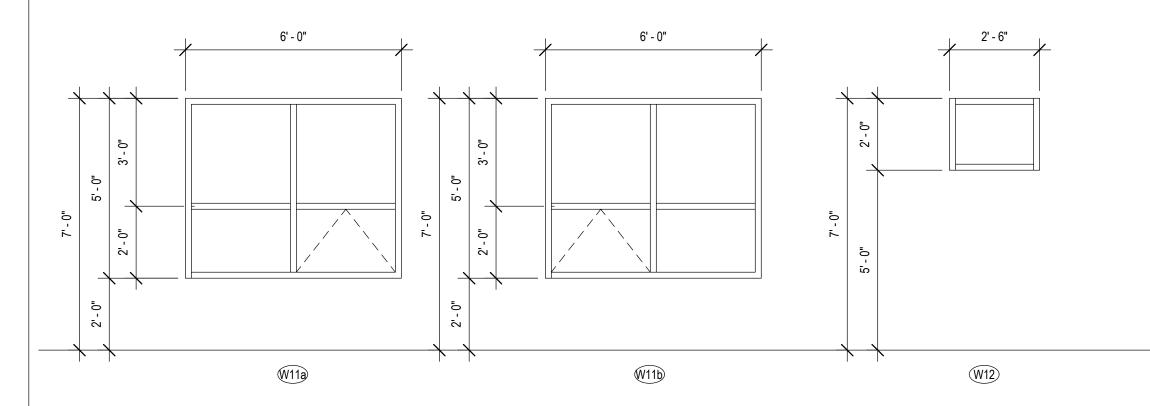

**<u>NOTE</u>**: THESE DRAWINGS ARE FORMATTED TO PRINT ON 22x34 PAPER SIZE. IF DRAWINGS ARE PRINTED ON 11x17 PAPER SIZE THE SCALE WILL BE 50% OF WHAT IS NOTED.

DIMENSIONS UNLESS NOTED AS BEING R.O. (ROUGH OPENING) ARE OUTSIDE MEASUREMENT OF WINDOW. THE SPACE BETWEEN THE WINDOW AND THE ROUGH OPENING IS ASSUMED TO BE 7/8" ALL THE WAY AROUND.











STEP

STEP

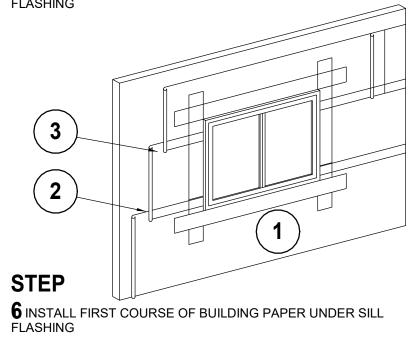

STEP

2. INSTALL SECOND COURSE OF BUILDING PAPER AT JAMBS 3. INSTALL THIRD COURSE OF BUILDING PAPER AT HEAD

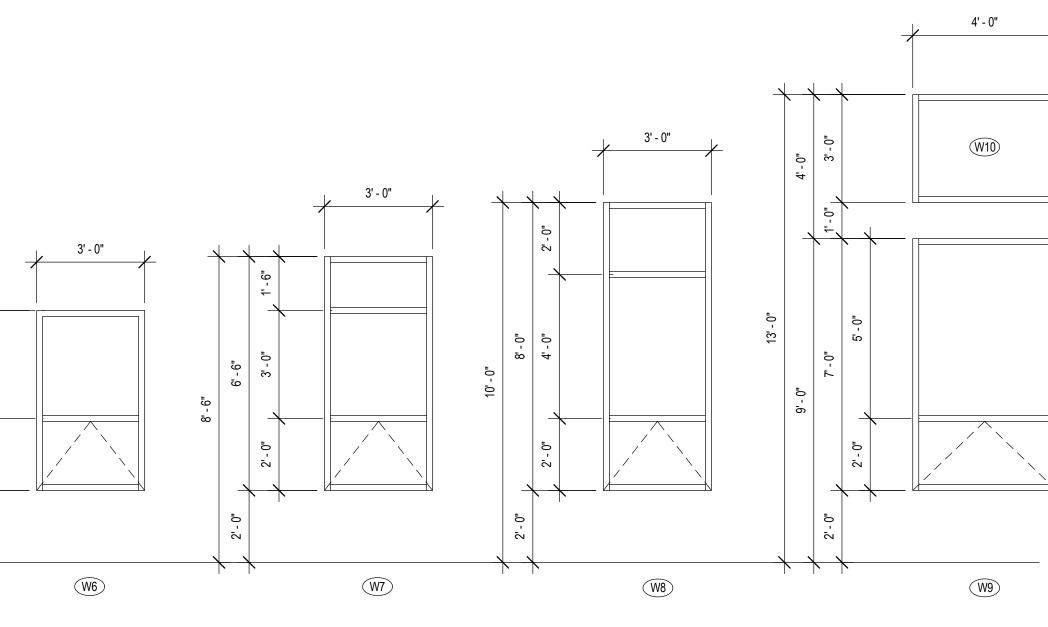

### WINDOW AND EXTERIOR DOOR SCHEDULE


SYMBOL	SIZE	QUANTITY	TYPE	API
(ED1)	5' - 0" x 7' - 0"	1	ENTRY DOOR WITH SIDE LIGHT	THE
ED2	5' - 0" x 7' - 0"	1	ENTRY DOOR WITH SIDE LIGHT	
ED3	3' - 0" x 7' - 0"	2	ENTRY DOOR w/ GLASS	
ED4	3' - 0" x 7' - 0"	2	ENTRY DOOR w/ GLASS	
W1a	3' - 6" x 3' - 0"	3	CASEMENT	
W1b	3' - 6" x 3' - 0"	3	CASEMENT	
(W2)	4' - 0" x 2' - 0"	6	AWNING	
W3	6' - 0" x 2' - 0"	2	FIXED	
W4a	3' - 0" x 3' - 6"	4	FIXED	
W4b	3' - 0" x 3' - 6"	3	CASEMENT	S
W4c	3' - 0" x 3' - 6"	3	FIXED	5 S
W5	4' - 0" x 5' - 0"	2	AWNING/FIXED	FL4
W6	3' - 0" x 5' - 0"	2	AWNING/FIXED	
W7	3' - 0" x 6' - 6"	2	AWNING / FIXED	
(W8)	3' - 0" x 8' - 0"	4	AWNING/FIXED	
(W9)	4' - 0" x 7' - 0"	6	AWNING/FIXED	
(W10)	4' - 0" x 3' - 0"	6	FIXED	
W11a	6' - 0" x 5' - 0"	1	AWNING/FIXED	
W11b	6' - 0" x 5' - 0"	1	AWNING/FIXED	
W12	2' - 6" x 2' - 0"	2	FIXED	

## GENERAL WINDOW INSTALLATION


1. CONFIRM ALL ROUGH OPENINGS WITH WINDOW SUPPLIER PRIOR TO FABRICATION.

2. ALL OPERABLE WINDOWS AND PATIO DOORS TO BE COMPLETE WITH SCREENS.


3. GLASS TYPE AND THICKNESS TO MEET CURRENT ALBERTA BUILDING CODE REQUIREMENT FOR ALL WINDOWS, DOORS AND SIDE LITES.

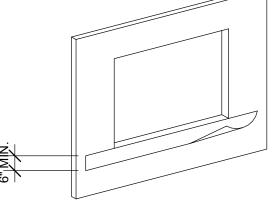


ECHANICALLY ATTACHED STRIP OF BUILDING PAPER AT SILL, EDGE OF OPENING, STAPLE ALONG TOP EDGE 1/2" FROM TOP OF

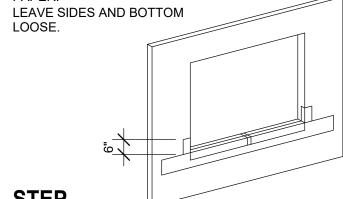

PPLY FIRST PIECE OF ADHESIVE-BACKED SILL FLASHING; APPLY PIECE OF ADHESIVE-BACKED FLASHING. EXTEND MIN. 6" VERTICALLY.

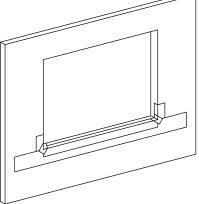


**B**ISTALL ADHESIVE-BACKED CORNER FLASHING PATCHES AT SILL.

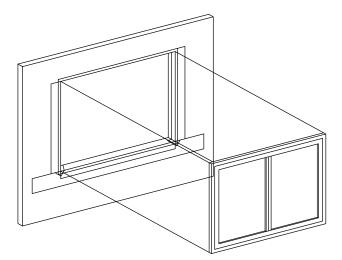

STALL BUILDING PAPER AT JAMBS.

APPLY SEALANT AT JAMBS AND HEAD; SEALANT CAN BE PLACED ON THE BACK SIDE OF THE NAILING FLANGE (BACK-CAULKED).

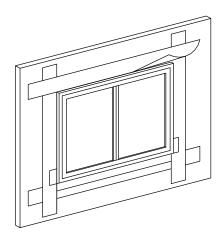

STALL WINDOW; INSTALL JAMB FLASHING THEN HEAD



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NO.	ISSUED FOR	DATE
6. 7. 8. 9. 10. 11. 12. 13.	BP DP Revised DP Revised BP Revised BP IFC ID Revisions Revised IFC	2023-04-13 2023-06-26 2023-08-23 2023-09-11 2023-09-28 2023-10-09 2024-03-21 2024-04-02

STAMP / SEAL

CLIENT NAME lan Sarna and Richard Greaves

PROJECT NAME

### 721 Duplex

721 3rd Street Canmore, Alberta

DRAWING TITLE

Window and Exterior Door Schedule


DRAWN BY:QM


PROJECT NUMBER 386-22

SHEET NO 

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ALL FLASHING TO COMPLY WITH THE CURRENT EDITION OF THE

FLASHING SHALL BE INSTALLED AT EVERY HORIZONTAL JUNCTION FINISH OVERLAPS THE LOWER FINISH.

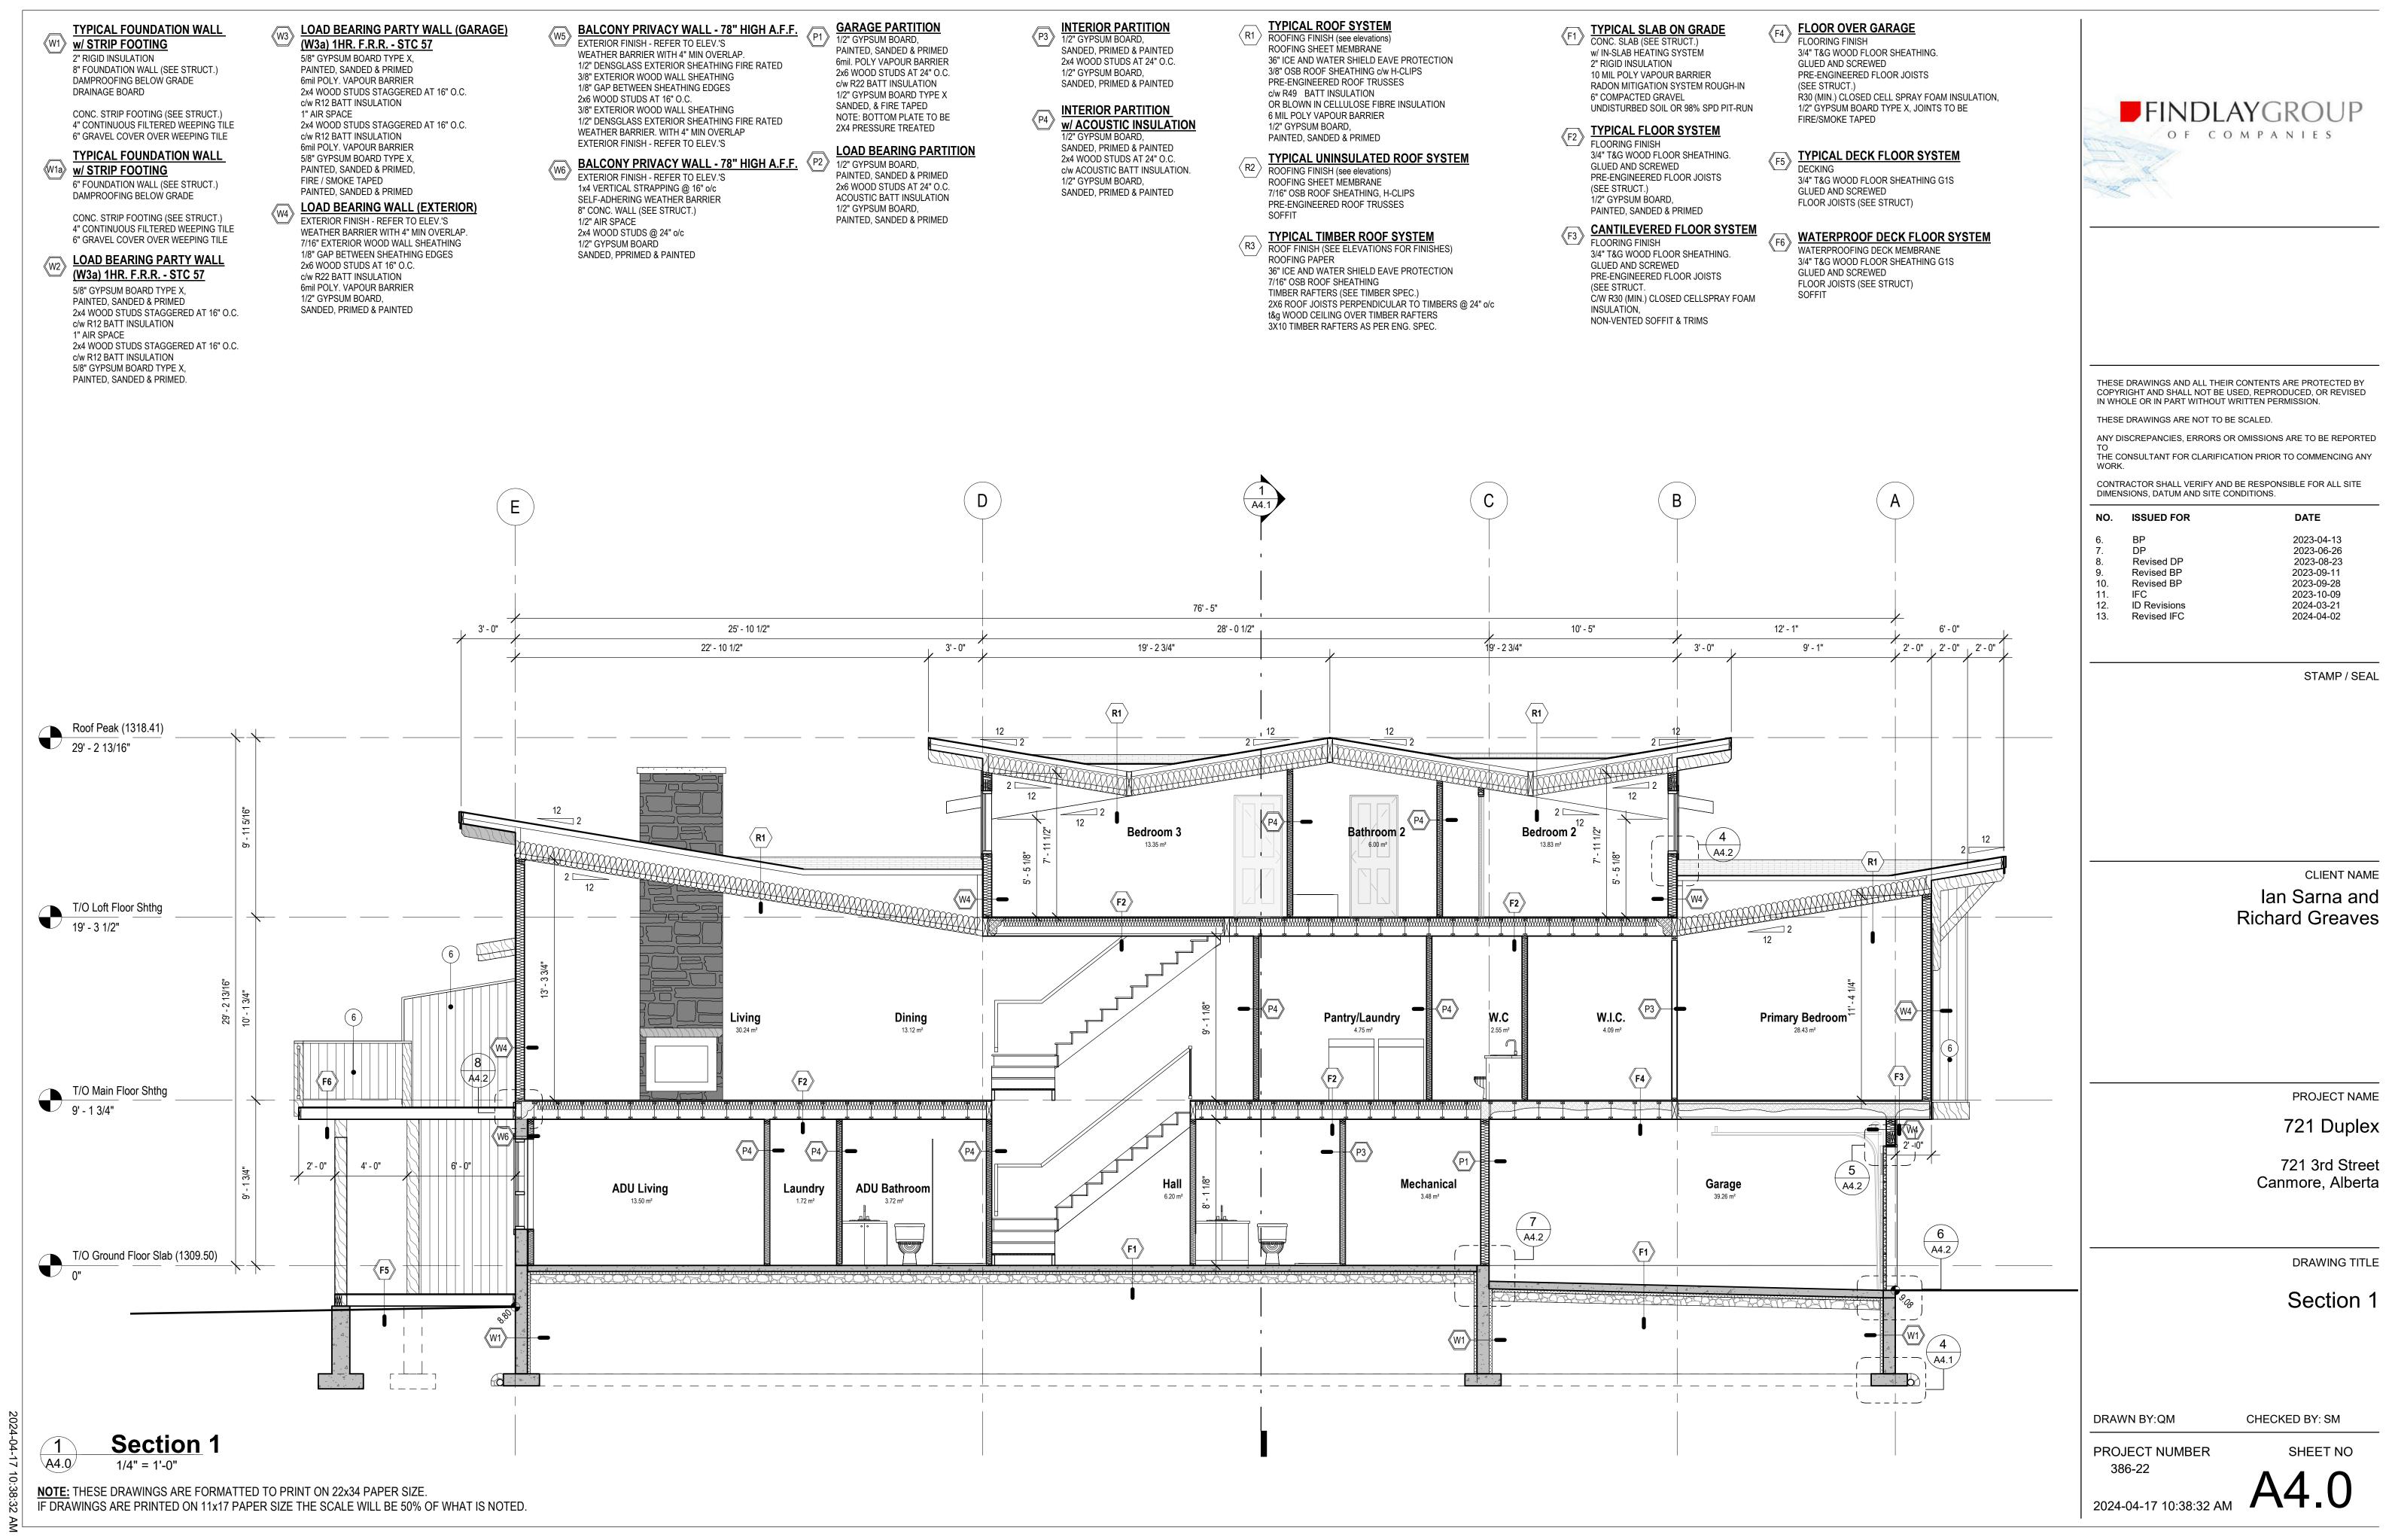EXCEPT AS PROVIDED IN SENTENCE (4), FLASHING SHALL BE APPLIED FROM THE BOTTOM OF THE EAVE TO THE TOP OF THE TRIM IS MORE THAN ONE-QUARTER OF THE HORIZONTAL OVERHANG OF THE EAVE.

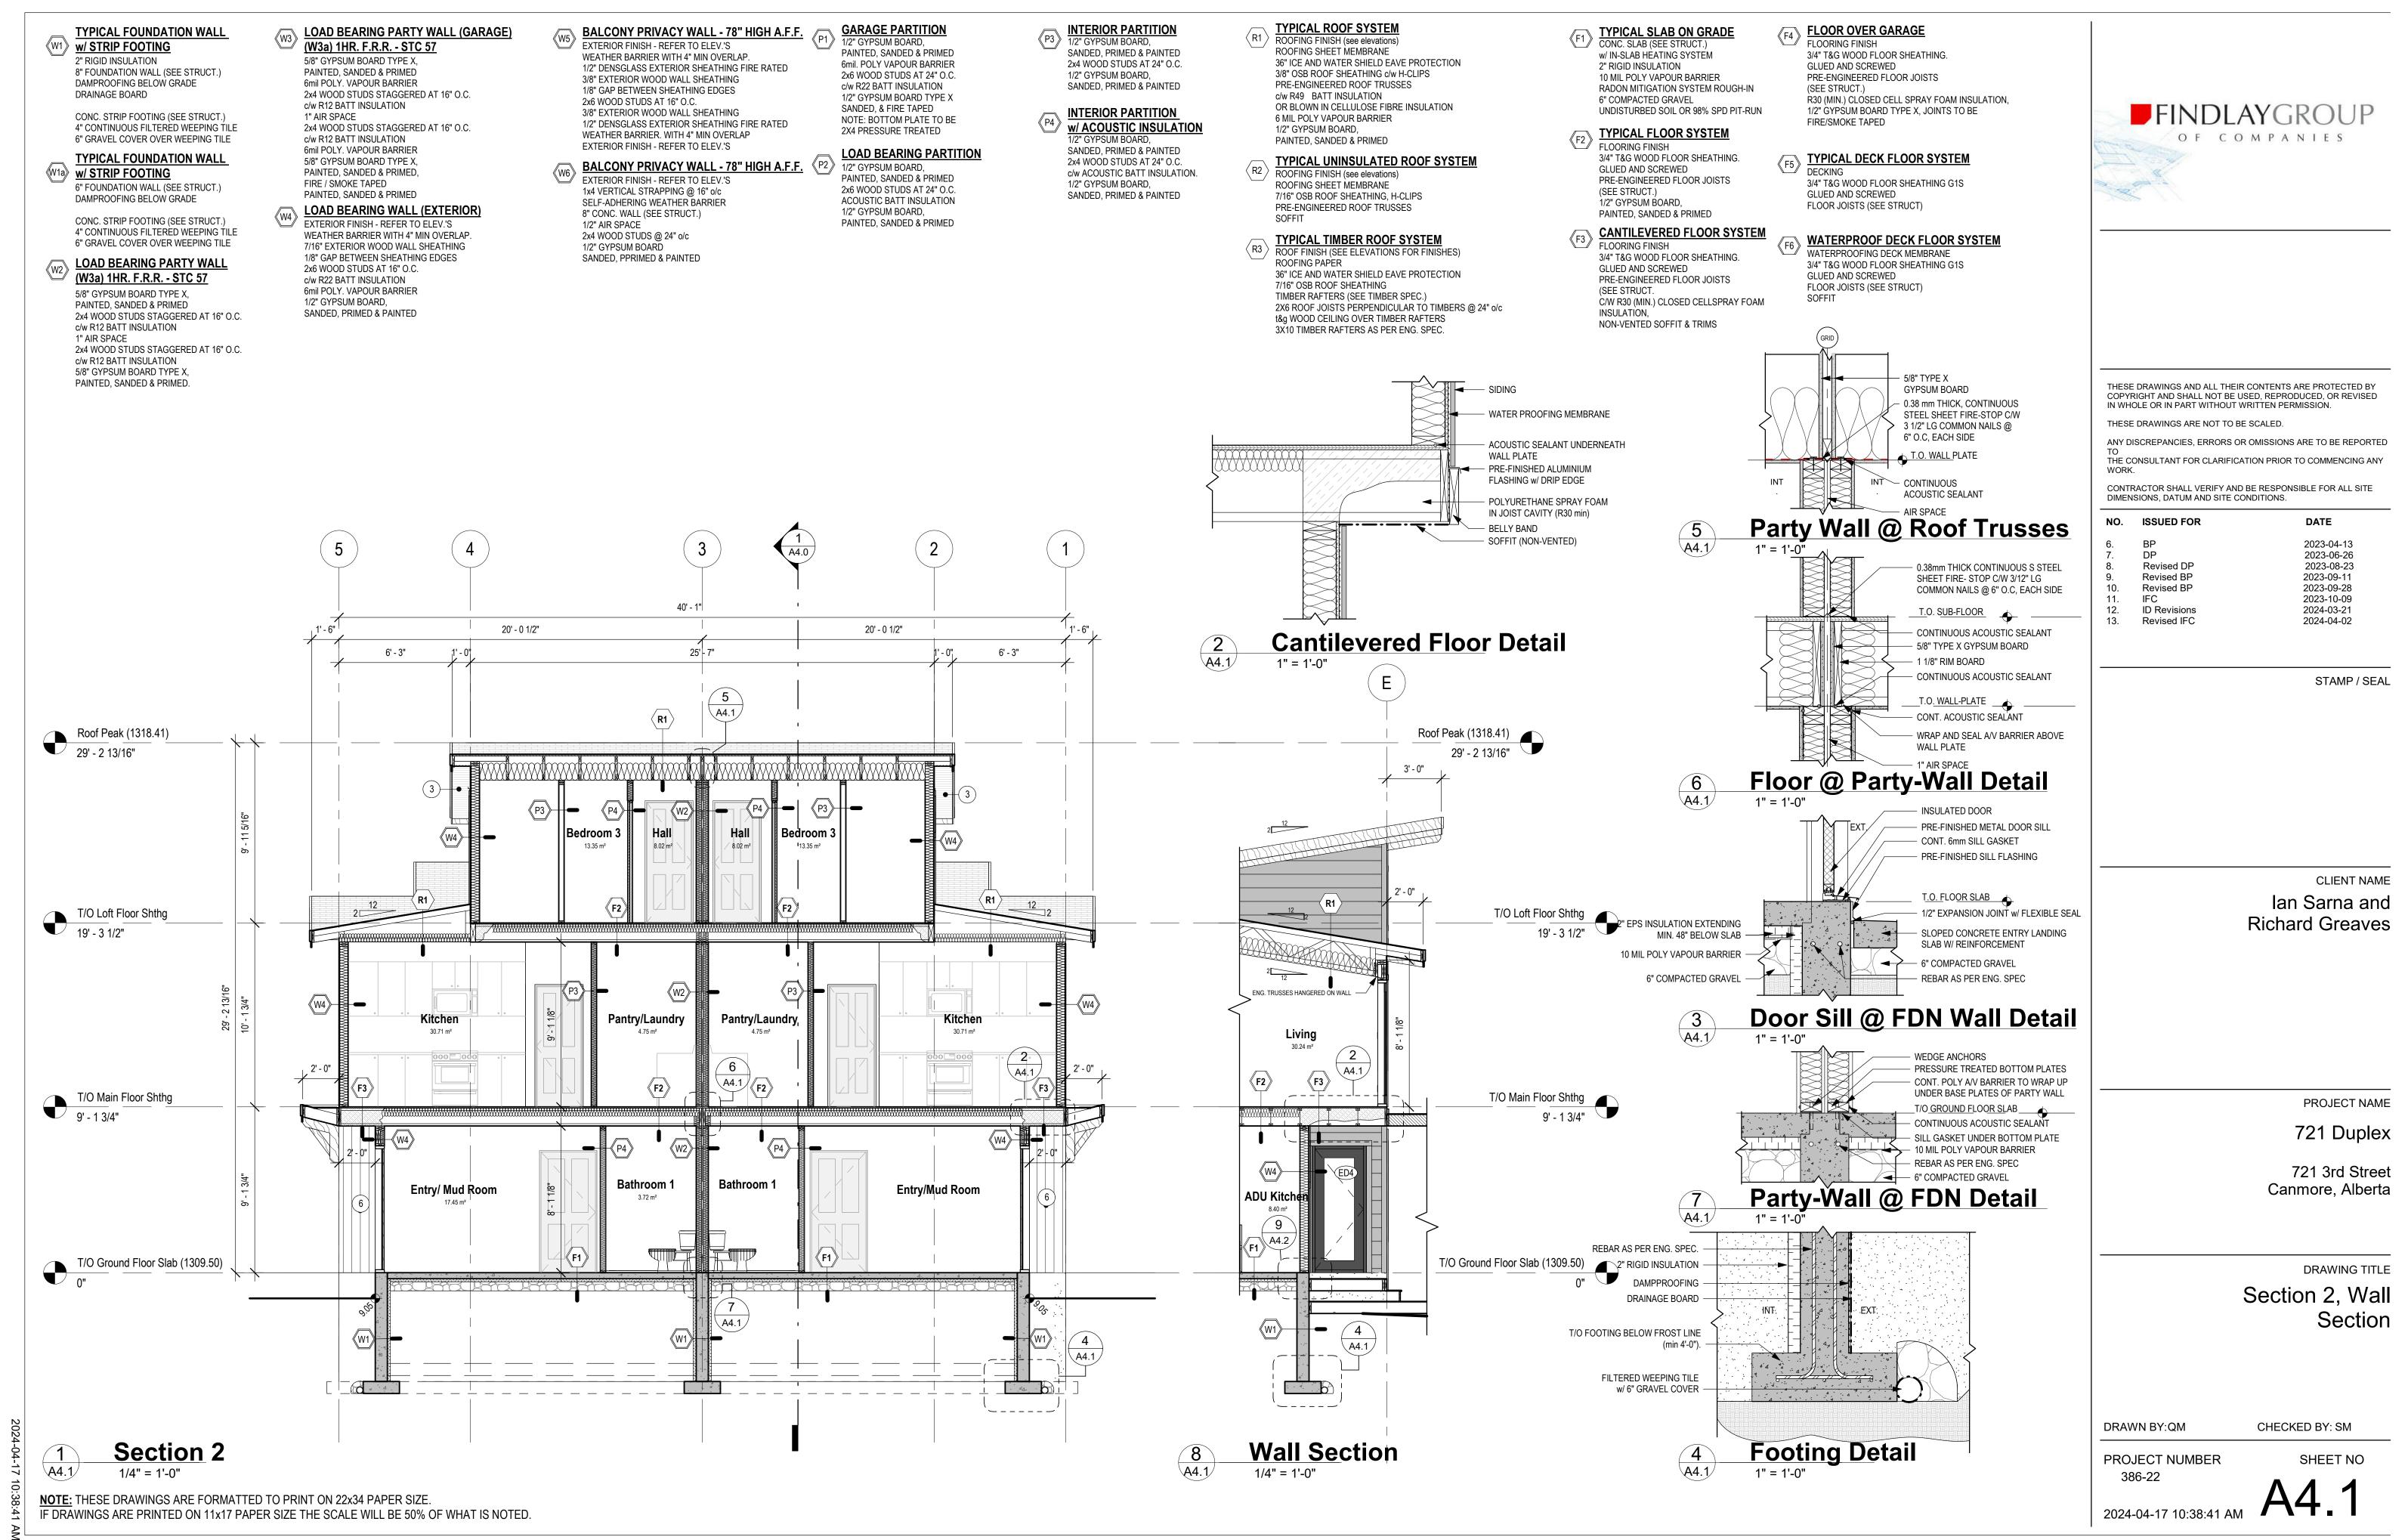FLASHING SHALL BE INSTALLED SO THAT IT EXTENDS UPWARDS NOT THE OUTSIDE EDGE.

WHERE A WINDOW OR EXTERIOR DOOR IS DESIGNED TO BE INSTALLED

2. FLASHING SHALL BE INSTALLED OVER ALL EXT WALL OPENINGS

MATERIAL AND CAULKED. BATTEN MATERIAL IS THEN FLASHED.

